

Chaires Fire Station Addition for Leon County Chaires, FL

CONSTRUCTION DOCUMENTS




Leon County - Chaires Fire Station Addition

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Project Code	Checked By:	RRI
14 April 2011		
Date		
Construc Documer		
Revisions		
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Cover Sheet

Tallahassee Florida

225 South Adams St, Tallahassee, FL 32301
Phone 850 224-6301 Fax 850 561-6978

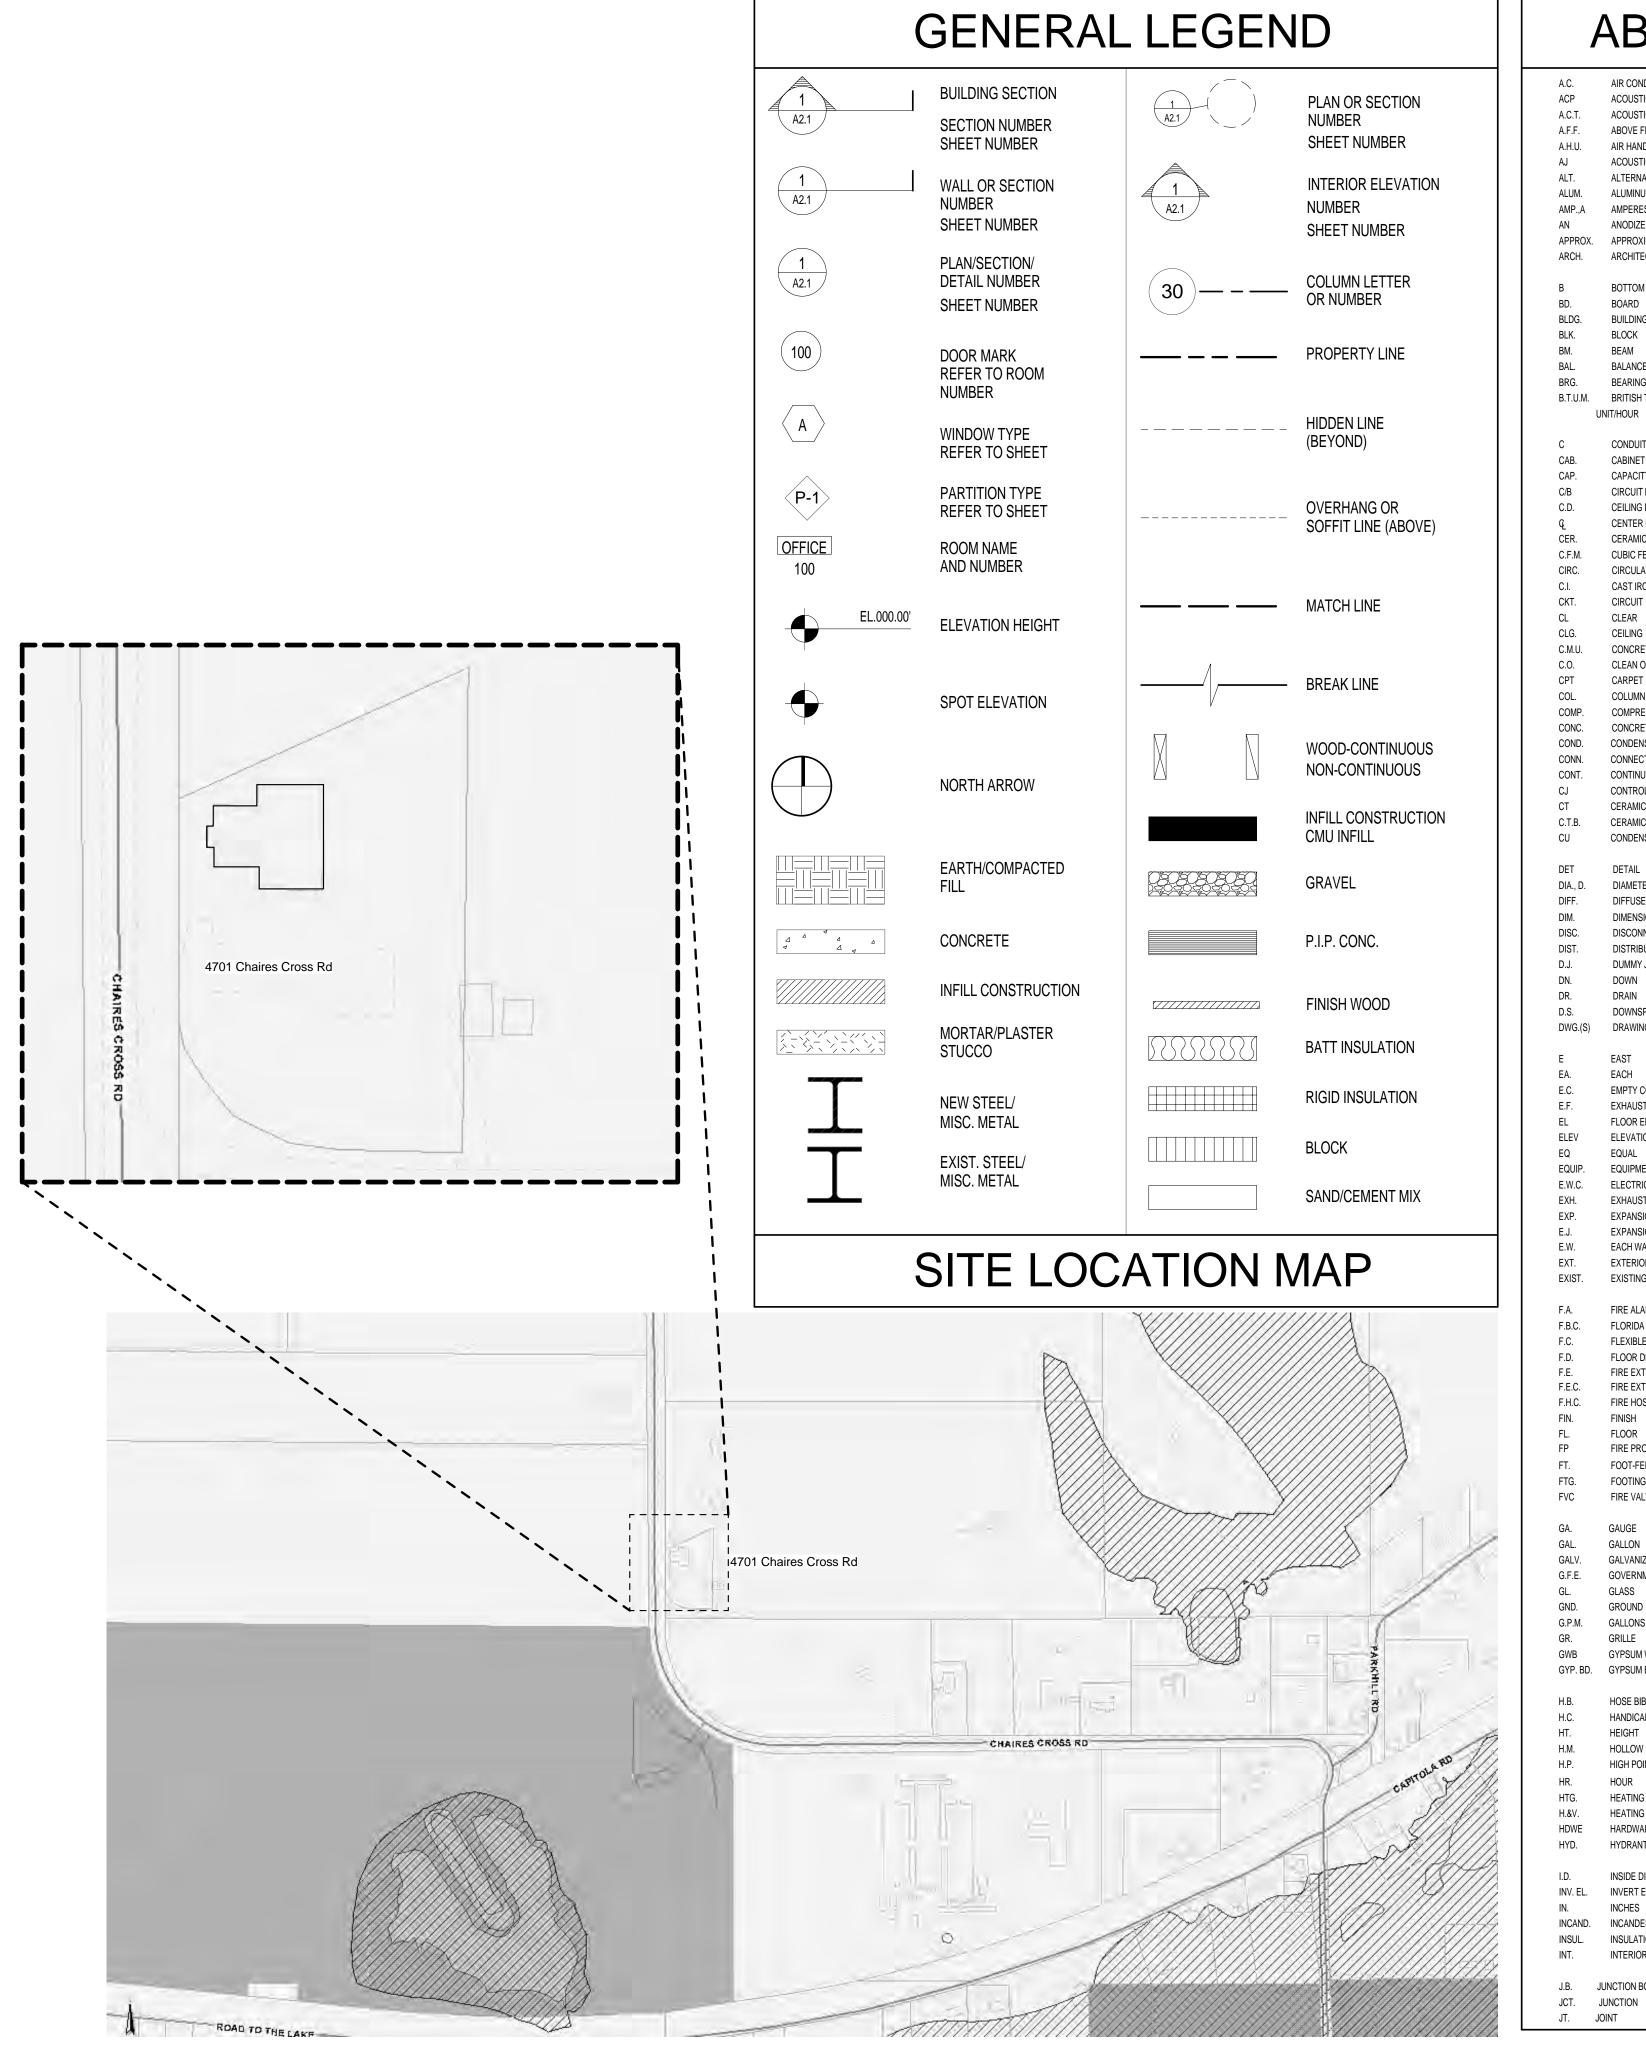

	ABBREVI	AI		IINDL	EX OF DRAWINGS
A.C. ACP	AIR CONDITIONED ACOUSTICAL PANEL	M. MAINT.	MOTOR MAINTENANCE		
A.C.T.	ACOUSTICAL TILE	MAX.	MAXIMUM	GENERAL	
A.F.F. A.H.U.	ABOVE FINISH FLOOR AIR HANDLING UNIT	M.D.P. MECH.	MAIN DISTRIBUTION PANEL MECHANICAL	CS-1	COVER SHEET
AJ.	ACOUSTICAL JOINT	MTL.	METAL	CS-2 CS-3	INDEX OF DRAWINGS CODE REVIEW
ALT.	ALTERNATE	MIN.	MINIMUM	33 0	OODE NEVEN
ALUM. AMP.,A	ALUMINUM AMPERES	MISC. MO	MISCELLANEOUS MASONRY OPENING		
AN	ANODIZED	MOD.BIT.	MODIFIED BITUMEN	CIVIL DRA	WINGS
APPROX. ARCH.	APPROXIMATELY ARCHITECTURAL	MR M.T.	MOISTURE RESISTANT METAL THRESHOLD	COVER	INDEX & GENERAL NOTES
AITOII.	AROHITEOTORAL	MTD.	MOUNTED	C1.0 C2.0	SITE PLAN GRADING PLAN
В	BOTTOM	MTG.	MOUNTING		
BD. BLDG.	BOARD BUILDING	N	NORTH	ΔR∩HITE(CTURAL DRAWINGS
BLK.	BLOCK	N.A.	NOT APPLICABLE	ANOTHIE	TOTAL DIAWINGS
BM. BAL.	BEAM BALANCE	N.I.C. NO.	NOT IN CONTRACT NUMBER		
BRG.	BEARING	NTS	NOT TO SCALE	A1.1 A1.2	DEMOLITION & NEW CONSTRUCTION PLANS ROOF & FRAMING PLANS, BUILDING ELEVATIONS/SECTIONS
B.T.U.M.	BRITISH THERMAL JNIT/HOUR	O.C.	ON CENTER	A4.1	BUILDING ELEVATIONS WALL SECTIONS & DETAILS
		O.C.E.W.	ON CENTER EACH WAY	A4.1	WALL SECTIONS & DETAILS
C CAB.	CONDUIT CABINET	O.D.	OUTSIDE DIAMETER		
CAB.	CAPACITY	O.H. OPNG.	OVERHEAD OPENING	ELECTRIC	AL DRAWINGS
C/B	CIRCUIT BREAKER	OPP.	OPPOSITE	E1.1	ELECTRICAL PLAN, NOTES @ DETAILS
C.D. Q	CEILING DIFFUSER CENTER LINE	P. LAM	PLASTIC LAMINATE		
CER.	CERAMIC	PART.	PARTITION		
C.F.M. CIRC.	CUBIC FEET/MINUTE CIRCULATING	PC PER.	PRECAST CONCRETE PERIMETER		
C.I.	CAST IRON	PER. PL.	PLATE		
CKT. CL	CIRCUIT CLEAR	PLBG.	PLUMBING PLYWOOD		
CL CLG.	CEILING	PLYW'D PNL.	PLYWOOD PANEL		
C.M.U.	CONCRETE MASONRY UNIT	PRESS.	PRESSURE		
C.O. CPT	CLEAN OUT CARPET	PSF PO	OUNDS/SQUARE FOOT POUNDS/SQUARE INCH		
COL.	COLUMN	PSTG.	POUNDS/SQUARE INCH GAGE		
COMP. CONC.	COMPRESSER CONCRETE	P.T. PT	PRESSURE TREATED PAINT		
COND.	CONDENSATE	PT PTD.	PAINT PAINTED		
CONN. CONT.	CONNECTION CONTINUOUS				
CONT.	CONTROL JOINT	QT QTR.	QUARRY TILE QUARTER		
CT	CERAMIC TILE	QUAN.	QUANTITY		
C.T.B. CU	CERAMIC TILE BASE CONDENSING UNIT	R	RADIUS		
		R.A.	RETURN AIR		
DET DIA., D.	DETAIL DIAMETER	RAD.	RADIUS RETURNAUR ORBU E		
DIFF.	DIFFUSER	R.A.G. R.A.R.	RETURN AIR GRILLE RETURN AIR REGISTER		
DIM.	DIMENSION	RD.	ROUND		
DISC. DIST.	DISCONNECT DISTRIBUTION	R.D. RDY.	ROOF DRAIN READY		
D.J.	DUMMY JOINT	RECIRC.	RECIRCULATING		
DN. DR.	DOWN DRAIN	RECP. REG.	RECEPTACLE REGISTER		
D.S.	DOWNSPOUT	REG. REINF.	REINFORCING		
DWG.(S)	DRAWING (S)	REQ.	REQUIRED		
E	EAST	RET. R.G.	RETURN RETURN GRILLE		
EA.	EACH	RM.	ROOM		
E.C. E.F.	EMPTY CONDUIT EXHAUST FAN	R.O. R.P.M.	ROUGH OPENING REVOLUTION/MINUTE		
EL	FLOOR ELEVATION	RWL	RAIN WATER LEADER		
ELEV EQ	ELEVATION EQUAL	S.A.	SUPPLY AIR		
EQUIP.	EQUIPMENT	S.A.T.	SUSPENDED ACOUSTICAL TILE		
E.W.C. EXH.	ELECTRIC WATER COOLER EXHAUST	SCH. SECT.	SCHEDULE SECTION		
EXP.	EXPANSION	SERV.	SERVICE		
E.J. E.W.	EXPANSION JOINT (EJ) EACH WAY	S.G.	SUPPLY GRILLE		
EXT.	EXTERIOR	SHT. SP	SHEET STAND PIPE		
EXIST.	EXISTING	SPEC.	SPECIFICATIONS		
F.A.	FIRE ALARM	SQ. FT. SRB	SQUARE FEET STRAIGHT RESILIENT BASE		
F.B.C.	FLORIDA BUILDING CODE	SS	STAINLESS STEEL		
F.C. F.D.	FLEXIBLE CONNECTION FLOOR DRAIN	STL STOR.	STEEL STORAGE		
F.E.	FIRE EXTINGUISHER & BRACKET	STRUC.	STRUCTURAL		
F.E.C. F.H.C.	FIRE EXTINGUISHER & CABINET FIRE HOSE CABINET W/ EXTINGUISHER	SUSP. SW.	SUSPENDED SWITCH		
FIN.	FINISH	GTV.			
FL. FP	FLOOR FIRE PROOFING	T	TOP		
FT.	FOOT-FEET	TEL. TEMP.	TELEPHONE TEMPERATURE		
FTG. FVC	FOOTING FIRE VALVE CABINET	THK.	THICK		
1 10	I INC. VALVE CADINE!	THD. T.O.W.(B)	THRESHOLD (THRESH) TOP OF WALL (BEAM)		
GA.	GAUGE	TOIL.	TOILET		
GAL. GALV.	GALLON GALVANIZED	TYP.	TYPICAL		
G.F.E.	GOVERNMENT FURNISHED EQUIPMENT	UNO	UNLESS NOTED OTHERWISE		
GL. GND.	GLASS GROUND	UR.	URINAL		
G.P.M.	GALLONS PER MINUTE	V.	VOLT		
GR. GWB	GRILLE GYPSUM WALLBOARD	VT	VINYL COMPOSITION TILE		
GWB GYP. BD.	GYPSUM WALLBOARD GYPSUM BOARD	V.C. V.E.J.	VITROUS CLAY VERTICAL EXPANSION JOINT		
ПD	HUGE BIBB	VENT.	VENTILATION		
H.B. H.C.	HOSE BIBB HANDICAP	VERT. V.I.F.	VERTICAL VERIFY IN FIELD		
HT.	HEIGHT	V.T.R.	VENT THRU ROOF		
H.M. H.P.	HOLLOW METAL HIGH POINT	W.	WATT		
HR.	HOUR	w. W/	WITH		
HTG.	HEATING & VENTIL ATING	W.C.	WATER CLOSET		
H.&V. HDWE	HEATING & VENTILATING HARDWARE	W.C.O. WD.	WASTE CLEAN OUT WOOD		
HYD.	HYDRANT	W.D.	WINDOW DIMENSION		
IIID.	INCIDE DIAMETED	WF	WIDE FLANGE		
	INSIDE DIAMETER	14/ 0	WATER CACE		
I.D. INV. EL.	INSIDE DIAMETER INVERT ELEVATION	W.G. WP.	WATER GAGE WEATHERPROOF		
I.D. INV. EL. IN.	INVERT ELEVATION INCHES	WP. WTR.	WEATHERPROOF WATER		
I.D. INV. EL.	INVERT ELEVATION	WP.	WEATHERPROOF		




Leon County - Chaires Fire Station Addition

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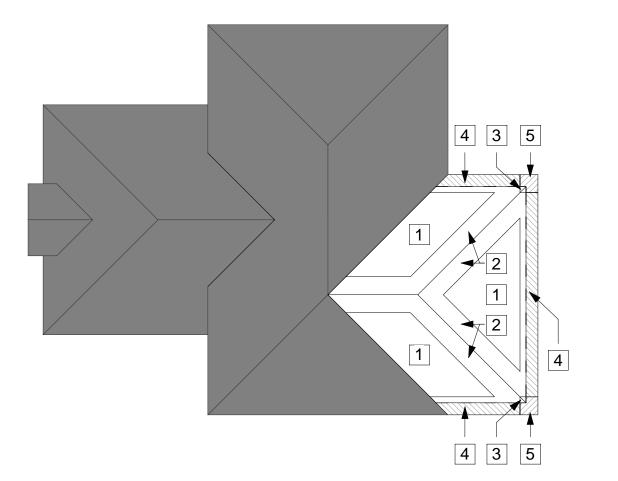
3,660 sq. ft. Floor area served

11,250 sq. ft. Allowable Floor Area / Extinguisher

Note: Total provided must also meet max. travel distance.

2 (Existing)

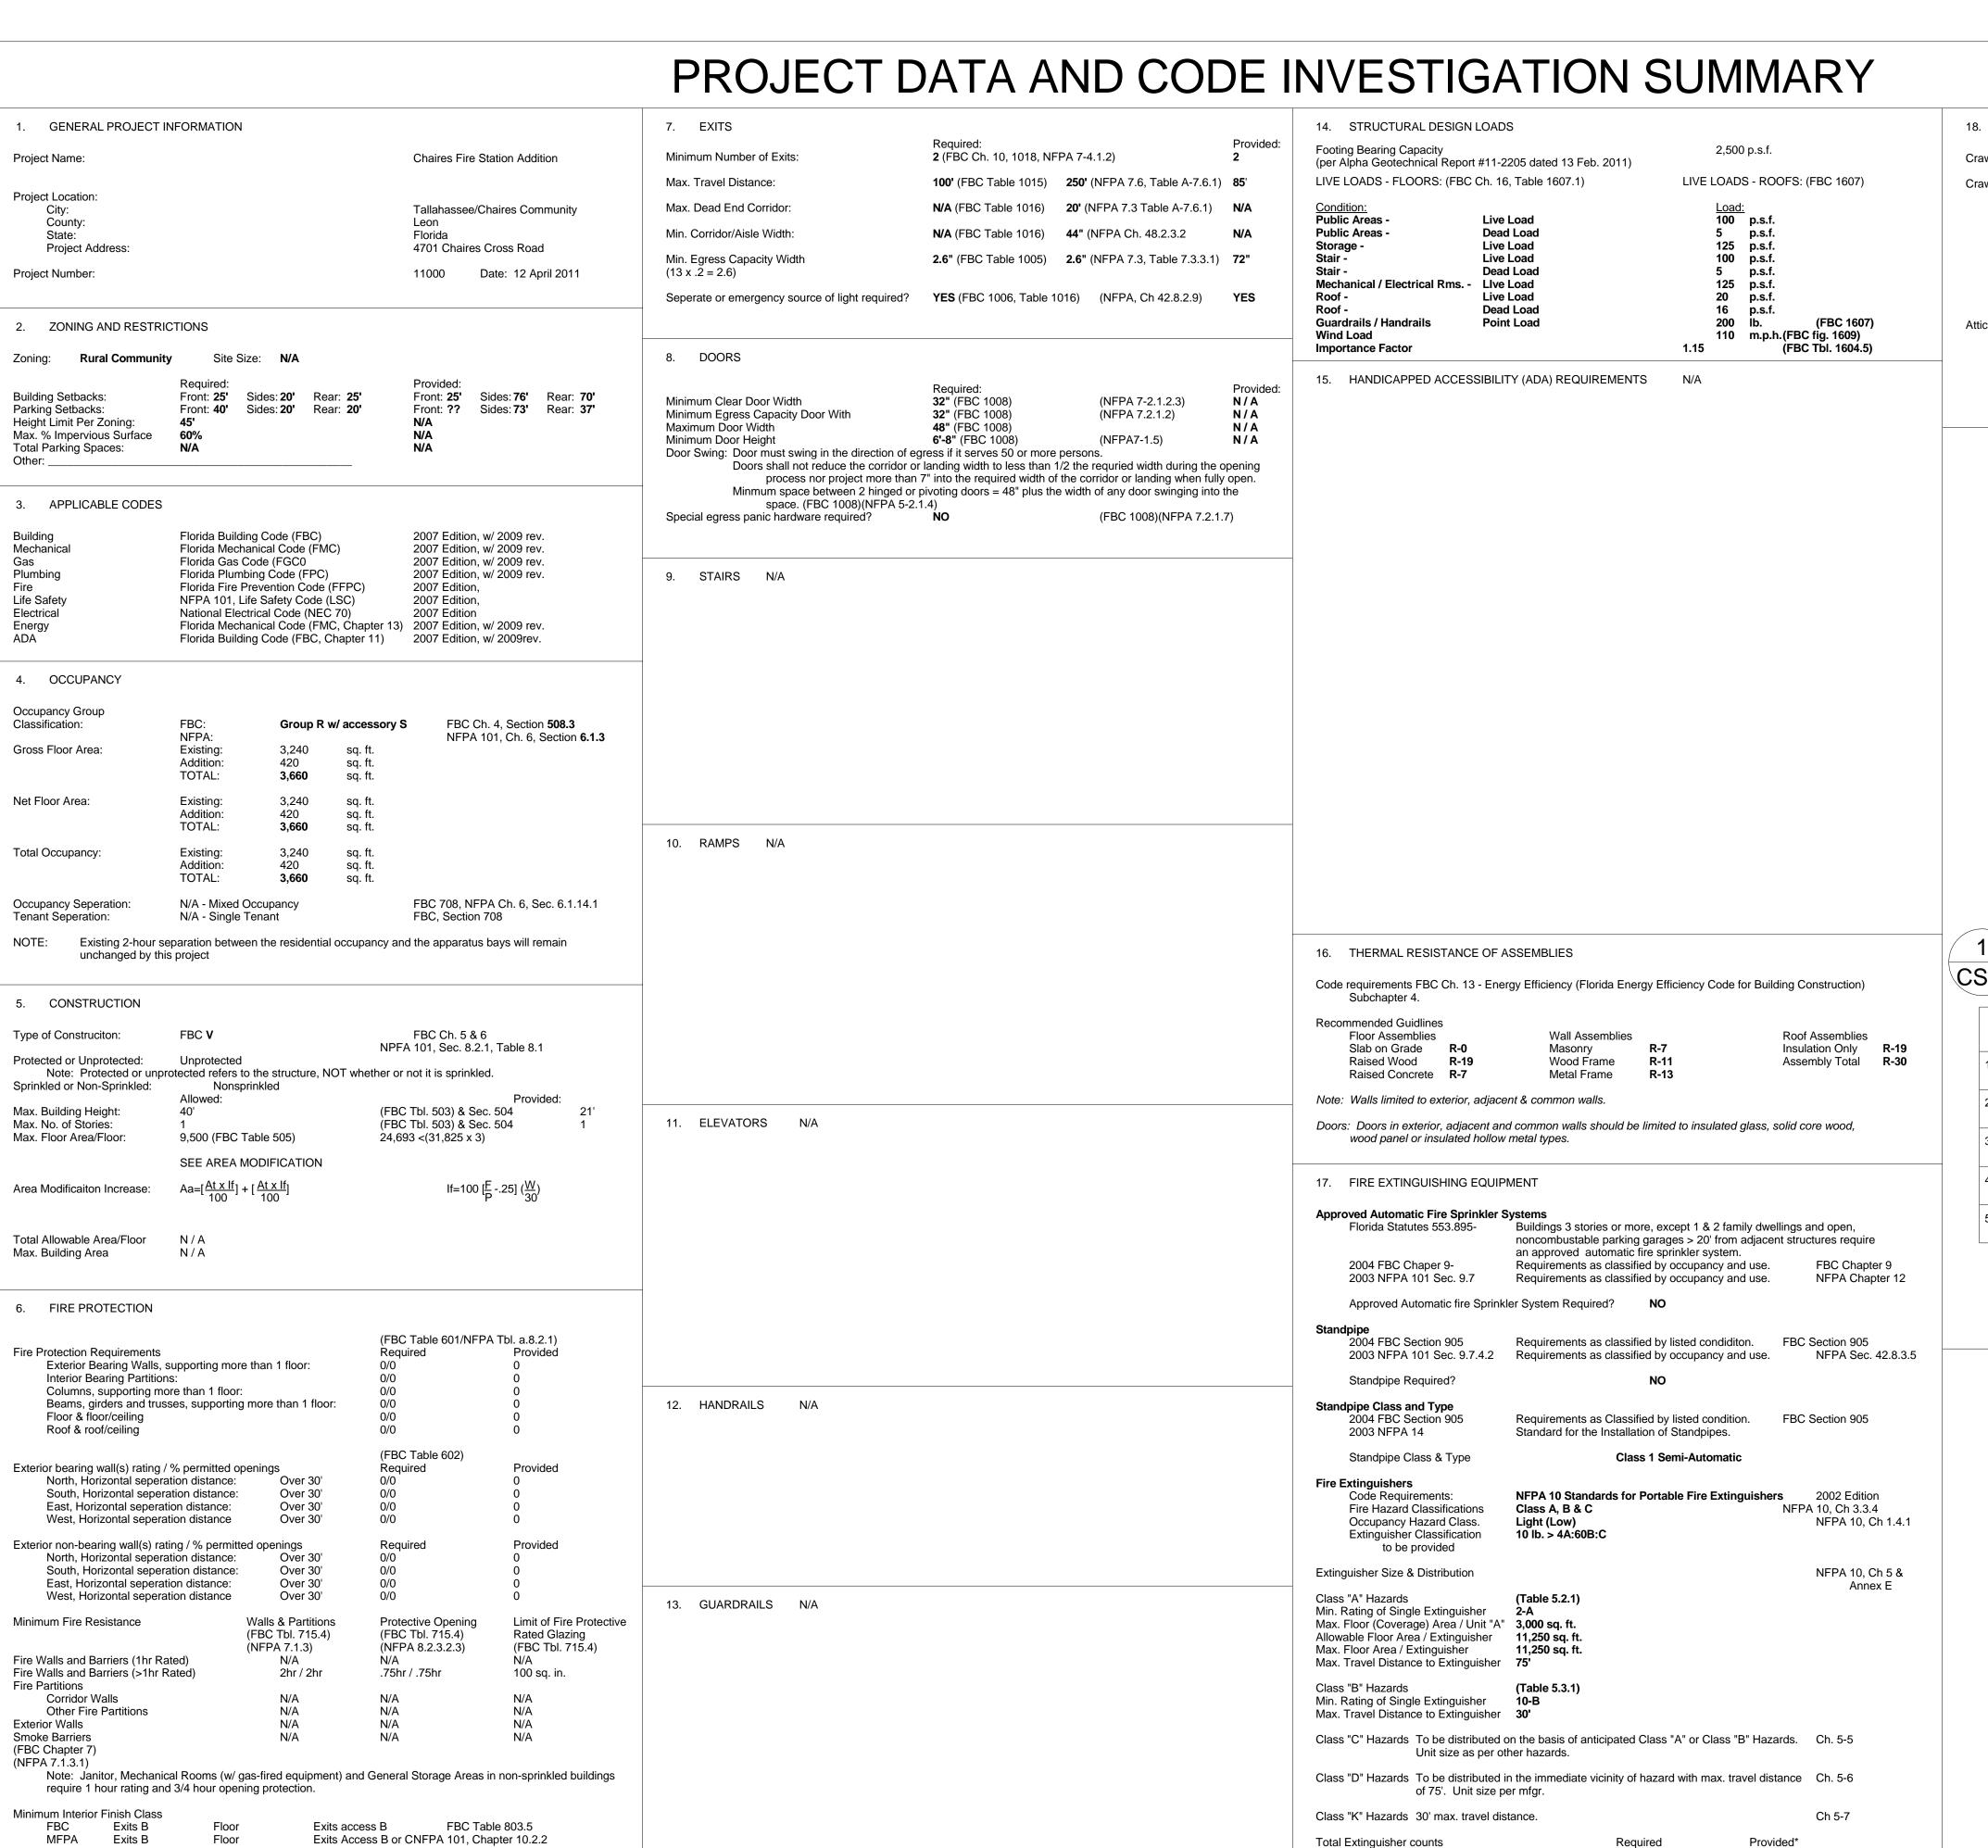RUCTURAL DESIGN	LOADS			18.	VENTILATION REQUIR	EMENTS	
earing Capacity a Geotechnical Report	#11-2205 dated 13 Feb. 2011)	2,500	0 p.s.f.	Crawl S	Space		(FBC 1203)
DS - FLOORS: (FBC	Ch. 16, Table 1607.1)	LIVE LOAD	OS - ROOFS: (FBC 1607)	Crawls	spaces under buildings s	hall be ventilated by mechanical means or four	ndation openings.
<u>:</u> eas -	Live Load	<u>Load</u> 100		ı	Mechanical Means	See Mechanical Plans & Specifications	
eas -	Dead Load Live Load	5	p.s.f. p.s.f.	1	Foundation Openings	Required	Provided
	Live Load Live Load Dead Load	125 100	p.s.f. p.s.f.	,	Wood Floor Systems	1 sf net open area / 150 sf crawlspace	N/A
cal / Electrical Rms	Live Load Live Load Dead Load	125 20 16	p.s.f. p.s.f. p.s.f. p.s.f.	ı	Floor Systems other than Wood	1.5 sf net open area / 15 l.f. of exterior wall	N/A
ls / Handrails nd ce Factor	Point Load	200 110 1.15	lb. (FBC 1607) m.p.h.(FBC fig. 1609) (FBC Tbl. 1604.5)		pace - Pitched Roof Required		(FBC 2309.7) Provided
NDICAPPED ACCES	SIBILITY (ADA) REQUIREMENTS	N/A	· · · · · · · · · · · · · · · · · · ·	1	reduction to 1:300 provid	entilating area to ceiling area of 1:150, or ling a vapor retarder on warm side of ceiling area by means of mechanical ventilators and ce vents.	



1	Wind I	Load
CS-3	1/16" = 1'-0	II

	ZONE	EFF	ECTIVE	TRIBUTA	ARY ARE	A (SQ. F	T.)
	ZONE	10	20	50	100	200	500
1	ROOF INTERIOR FIELD	+12 - 20	+11 - 19	+10 - 18	+ 9 - 18	+ 9 - 18	+ 9 - 18
2	ROOF EDGES, HIPS & PEAKS	+12 - 34	+11 - 31	+10 - 28	+ 9 - 25	+ 9 - 25	+ 9 - 25
3	ROOF CORNERS & RIDGE AT EDGE	+12 - 50	+11 - 46	+10 - 42	+ 9 - 39	+ 9 - 39	+ 9 - 39
4	ROOF EDGES & HIPS, OVERHANG	+12 - 43	+11 - 43	+10 - 43	+ 9 - 43	+ 9 - 43	+ 9 - 43
5	ROOF CORNERS & RIDGE, OVERHANG	+12 - 69	+11 - 63	+10 - 54	+ 9 - 48	+ 9 - 48	+ 9 - 48

EDGE ZONE WIDTH = 3'-0" IMPORTANCE FACTOR 1 = 1.15 —— WIND SPEED = 110 MPH EXPOSURE CATEGORY = B

MEAN ROOF HEIGHT = 16'-0" WIND PRESSURES FOR ROOF & WALLS (PSF) (COMPONENTS & CLADDING)



Leon County - Chaires Fire Station Addition

Drawn By:

Checked By: RRB

JH2

11000

Project Code

14 April 2011 Construction Documents Revisions

DATA & CODE

Fax 850 561-6978

Phone 850 224-6301

FBC Chapter 9,

NFPA 101, Chapter 12

Manual Fire Alarm Required YES

PERMIT DOCUMENTS FOR

LEON COUNTY CHAIRES FIRE SPATION #12 ALTERATIONS

4701 CHAIRES CROSS ROAD TALLAHASSEE, FLORIDA 32301

ADMINISTRATIVE STREAMLINED APPROVAL PROCESS

SITE APPLICATION



OWNER / CLIENT: 301 S. MONROE STREET TALLAHASSEE, FL 32301

> TAX I.D. NO: 12-34-20-802-000-0

VICINITY MAP

LEON COUNTY COMMISSIONERS

SUNSHINE STATE ONE CALL 811

BEFORE YOU DIG, GRADE, OR EXCAVATE FOR THE MARKING OF UNDERGROUND

INDEX OF DRAWINGS

<u>TITLE</u> SHEET NUMBER **COVER SHEET** SITE PLAN GRADING PLAN + EROSION CONTROL PLAN

CONSTRUCTION SEQUENCE:

1. A PRE-CONSTRUCTION CONFERENCE WITH THE COUNTY ENVIRONMENTAL INSPECTOR IS REQUIRED PRIOR TO BEGINNING ANY CONSTRUCTION ACTIVITY AT THE SITE. 2. EROSION & SEDIMENTATION CONTROL DEVICES SHALL BE PROPERLY INSTALLED PER THE APPROVED PLAN, AND HAVE BEEN INSPECTED AND APPROVED BY LEON COUNTY'S 3. "FLAG" THE LIMITS OF CLEARING.

5. CONSTRUCTION OF THE BUILDING ADDITION WILL OCCUR NEXT. SITE IMPROVEMENTS SUCH AS PAVING OPERATIONS WILL BE FINALIZED AT THE COMPETITION OF THE BUILDING EXPANSION.

4. AFTER THE ON-SITE PRE-CONSTRUCTION MEETING, CLEARING AND GRADING OPERATIONS CAN

6. AN AS-BUILT SURVEY, COMPLIANCE NARRATIVE, AND STORMWATER OPERATING AMENDMENT SHALL BE SUBMITTED TO LCGEM ENVIRONMENTAL DIVISION AT LEAST TWO WEEKS PRIOR TO REQUESTING A FINAL INSPECTION.

PLANS PREPARED BY:



C.A. #28124 36 Jasper Thomas Road Crawfordville, Fl 32327 PH 850-926-2593 FX 850-926-9257

CALL BEFORE YOU DIG!

GENERAL EARTHWORK NOTES:

1. ALL STRUCTURES, CONCRETE, TREES, BRUSH AND RUBBISH SHALL BE REMOVED AND

2. ALL DISTURBED AREAS SHALL BE STABILIZED 24 HRS PRIOR TO ANY RAIN EVENT. ALL

5. EROSION CONTROL BALES OR SILT FENCE SHALL BE PLACED AT THE TOE AND DRAINAGE OUTFALL POINTS OF ALL SLOPES 4:1 OR STEEPER TO PREVENT SILTATION ON STREETS. REFER

TO STORMWATER MANAGEMENT PLAN FOR DETAIL AND LOCATION OF EROSION CONTROL

6. THE CONTRACTOR SHALL COMPLY WITH ALL LOCAL, COUNTY AND STATE REGULATIONS

7. NATURAL VEGETATION SHALL BE RETAINED AND PROTECTED WHEREVER POSSIBLE. EXPOSURE OF SOIL TO EROSION BY REMOVAL OR DISTURBANCE OF VEGETATION SHALL BE LIMITED TO THE AREA REQUIRED FOR IMMEDIATE CONSTRUCTION OPERATIONS AND FOR THE SHORTEST PRACTICAL PERIOD OF TIME. ALL TREES TO BE REMOVED OR RELOCATED WILL BE MARKED BY THE OWNER

8. TOPSOIL SHALL BE STOCKPILED TO THE EXTENT PRACTICABLE ON THE SITE FOR USE ON AREAS TO BE REVEGETATED. ANY AND ALL STOCKPILES SHALL BE LOCATED AND PROTECTED

9. AT ALL TIMES, THE PROPERTY SHALL BE MAINTAINED AND/OR WATERED TO PREVENT

FROM EROSIVE ELEMENTS. ANY STOCKPILE LOCATIONS SHALL BE PRE-APPROVED BY THE COUNTY

WIND-CAUSED EROSION. EARTHWORK OPERATIONS SHALL BE DISCONTINUED WHEN FUGITIVE DUST

SIGNIFICANTLY IMPACTS ADJACENT PROPERTY. IF EARTHWORK IS COMPLETE OR DISCONTINUED AND DUST FROM THE SITE CONTINUES TO CREATE PROBLEMS, THE CONTRACTOR SHALL IMMEDIATELY INSTITUTE MITIGATIVE MEASURES AND SHALL CORRECT DAMAGE TO ADJACENT

10. ALL EXISTING UTILITY LINE LOCATIONS MUST BE VERIFIED BY THE CONTRACTOR PRIOR TO

ON UNIFORM TRAFFIC CONTROL DEVICES" AND THE CONTRACTOR IS DIRECTED TO PAY

PARTICULAR ATTENTION TO THE SELECTION OF CONSTRUCTION ZONE TRAFFIC.

13. CONSTRUCTION STAKING TO BE PROVIDED BY THE CONTRACTOR.

WRITTEN PERMISSION FROM LEON COUNTY ENVIRONMENTAL DIVISION.

11. ALL TRAFFIC CONTROL DEVICES SHALL COMPLY WITH THE LATEST VERSION OF THE "MANUAL

12. THE TYPE, SIZE, LOCATIONS AND NUMBER OF KNOWN UNDERGROUND UTILITIES ARE PLOTTED FROM THE BEST AVAILABLE INFORMATION. HOWEVER, EXACT LOCATIONS AND THE TYPE OF EXISTING UTILITIES ARE APPROXIMATE AND NOT NECESSARILY ALL INCLUSIVE. IT SHALL BE THE CONTRACTOR'S RESPONSIBILITY TO VERIFY THE EXISTENCE AND LOCATION OF ALL UNDERGROUND UTILITIES WITHIN THE AREA OF WORK. BEFORE COMMENCING CONSTRUCTION, THE CONTRACTOR

14. ALL CONSTRUCTION SHALL BE COMPLETED IN ACCORDANCE WITH THE CONTRACT DOCUMENTS. THE PLANS AND APPLICABLE LEON COUNTY, UNLESS OTHERWISE NOTED IN THE CONTRACT

DOCUMENTS CANNOT SUPERSEDE APPROVED PERMIT DOCUMENTS AND SPECIFICATIONS WITHOUT

ACCEPTANCE BY THE OWNER. THE OWNERS RESERVE THE RIGHT TO ACCEPT OR REJECT ANY SUCH MATERIALS AND WORKMANSHIP THAT DOES NOT CONFORM TO THEIR STANDARDS AND

16. THE CONTRACTOR SHALL BE RESPONSIBLE FOR THE ACCEPTANCE AND CONTROL OF ALL

17. THE CONTRACTOR SHALL HAVE A COPY OF THE CONTRACT PLANS AND SPECIFICATIONS ON

18. THE OWNER WILL BE RESPONSIBLE FOR COORDINATING CONSTRUCTION ACCESS APPROVALS,

21. THE CONTRACTOR SHALL NOTIFY THE OWNER AND ENGINEER OF ANY CONDITIONS THAT ARE

22. THE CONTRACTOR SHALL BE RESPONSIBLE FOR RESTORING ALL SURFACES AND RELATED STRUCTURES INCLUDING BUT NOT LIMITED TO CURB AND GUTTER, SIDEWALK, ASPHALT AND

23. COMPACTION FOR ALL FILL ZONES AND SUBGRADES SHALL BE AT MINIMUM 95-PERCENT OF THE MODIFIED PROCTOR DRY DENSITY (ASTM D-1557) AND WITHIN 1-PERCENT BELOW AND 3-PERCENT ABOVE THE OPTIMUM MOISTURE CONTENT. FILL LIFTS SHALL NOT BE PLACED IN

24. ALL RIP RAP AND BEDDING MATERIAL FOR RIP RAP SHALL MEET THE REQUIREMENTS OF THE NORTHWEST FLORIDA WATER MANAGEMENT DISTRICT, UNLESS OTHERWISE NOTED ON THE PLAN

CONTRACTOR AND SHALL INCLUDE SURVEYING AT THE CONTRACTOR'S EXPENSE, IF REQUIRED TO

27. EXISTING TOPOGRAPHY AND VERTICAL DATUM INFORMATION PROVIDED BY EDWIN BROWN & ASSOCIATES, 2813 CRAWFORDVILLE HWY, CRAWFORDVILLE, FL 32327. ELEVATIONS ARE BASED ON

29. IF DURING CONSTRUCTION OR OPERATION OF THE STORMWATER MANAGEMENT SYSTEM, A STRUCTURAL FAILURE IS OBSERVED THAT HAS THE POTENTIAL TO CAUSE THE DIRECT DISCHARGE

OF SURFACE WATER INTO THE FLORIDIAN AQUIFER SYSTEM, CORRECTIVE ACTIONS DESIGNED OR APPROVED BY A REGISTERED PROFESSIONAL SHALL BE TAKEN AS SOON AS PRACTICALLY

MUST BE PROVIDED AS SOON AS PRACTICAL TO THE NWFWMD FOR REVIEW AND APPROVAL AND AS BUILT MATERIALS SHALL BE SUBMITTED TO THE LEON COUNTY ENVIRONMENTAL DIVISION THAT

POSSIBLE TO CORRECT THE FAILURE. A REPORT PREPARED BY A REGISTERED PROFESSIONAL

PROVIDES REASONABLE ASSURANCE THAT THE BREACH WILL BE PERMANENTLY CORRECTED.

30. ALL ROOF DRAINAGE SHALL BE DIRECTED INTO THE STORMWATER MANAGEMENT SYSTEM.

25. ALL CONCRETE SHALL MEET FDOT SPECIFICATIONS. ALL CONCRETE SHALL USE TYPE II

26. PROPERTY PINS DISTURBED DURING CONSTRUCTION SHALL BE RESTORED BY THE

28. THE CONTRACTOR SHALL NOTIFY THE GEOTECHNICAL ENGINEER OF EARTHWORK

CONSTRUCTION TO ALLOW FOR MONITORING AND COMPACTION TESTING.

19. UNLESS OTHERWISE INDICATED, PIPE LENGTHS SHOWN ON THESE PLANS ARE BASED ON HORIZONTAL DISTANCES BETWEEN STATIONS AND ARE NOT NECESSARILY THE TRUE LENGTHS OF

THE PIPE. THE CONTRACTOR SHALL PROVIDE AND INSTALL THE TRUE LENGTH REQUIRED. 20. THE CONTRACTOR SHALL BE RESPONSIBLE FOR PROTECTING EXISTING FEATURES AND FACILITIES FROM DAMAGE AND SHALL REPAIR OR REPLACE DAMAGED FEATURES AND FACILITIES

FLOWS INCLUDING SURFACE WATER AND GROUNDWATER INFLOW INTO THE PROJECT SITE.

DOCUMENTS. WORK NOT INCLUDED IN ANY OF THESE CRITERIA SHALL BE CONDUCTED IN

ACCORDANCE WITH FDOT SPECIFICATIONS AND THE GREEN BOOK STANDARDS. CONTRACT

15. ALL MATERIALS AND WORKMANSHIP SHALL BE SUBJECT TO THE INSPECTION AND

3. ALL FILL AREAS SHALL BE COMPACTED IN ACCORDANCE WITH THE GEOTECHNICAL ENGINEER'S

DISTURBED AREAS SHALL BE STABILIZED WITHIN 72 HRS AFTER FINAL GRADING.

4. ALL SLOPES STEEPER THAN 4:1 SHALL BE SODDED.

PERTAINING TO GRADING, DUST AND EROSION.

SHALL FIELD VERIFY ALL UNDERGROUND UTILITIES.

SPECIFICATIONS IN THE CONTRACT DOCUMENTS.

FOR ALL PROPERTIES ASSOCIATED WITH THE CONSTRUCTION.

NOT CONSISTENT WITH THE DRAWINGS AND/OR SPECIFICATIONS.

CONCRETE WEARING SURFACES TO THE ORIGINAL CONDITIONS.

NORTH AMERICAN VERTICAL DATUM 1988 (NAVD88).

SITE AT ALL TIMES.

AT HIS OWN EXPENSE.

GREATER THAN 8-INCH BULK LIFTS.

ACCEPTABLY DISPOSED OF.

ENVIRONMENTAL INSPECTOR.

RECOMMENDATIONS.

CALL 2-BUSINESS DAYS IN ADVANCE MEMBER UTILITIES


ENVIRONMENTAL MANAGEMENT OR DESIGNEE

DIRECTOR OF GROWTH AND

PREPARED UNDER DIRECTION OF:

LESLIE A. HOPE, P.E. #56452 HYDRA ENGINEERING, LLC

DATE

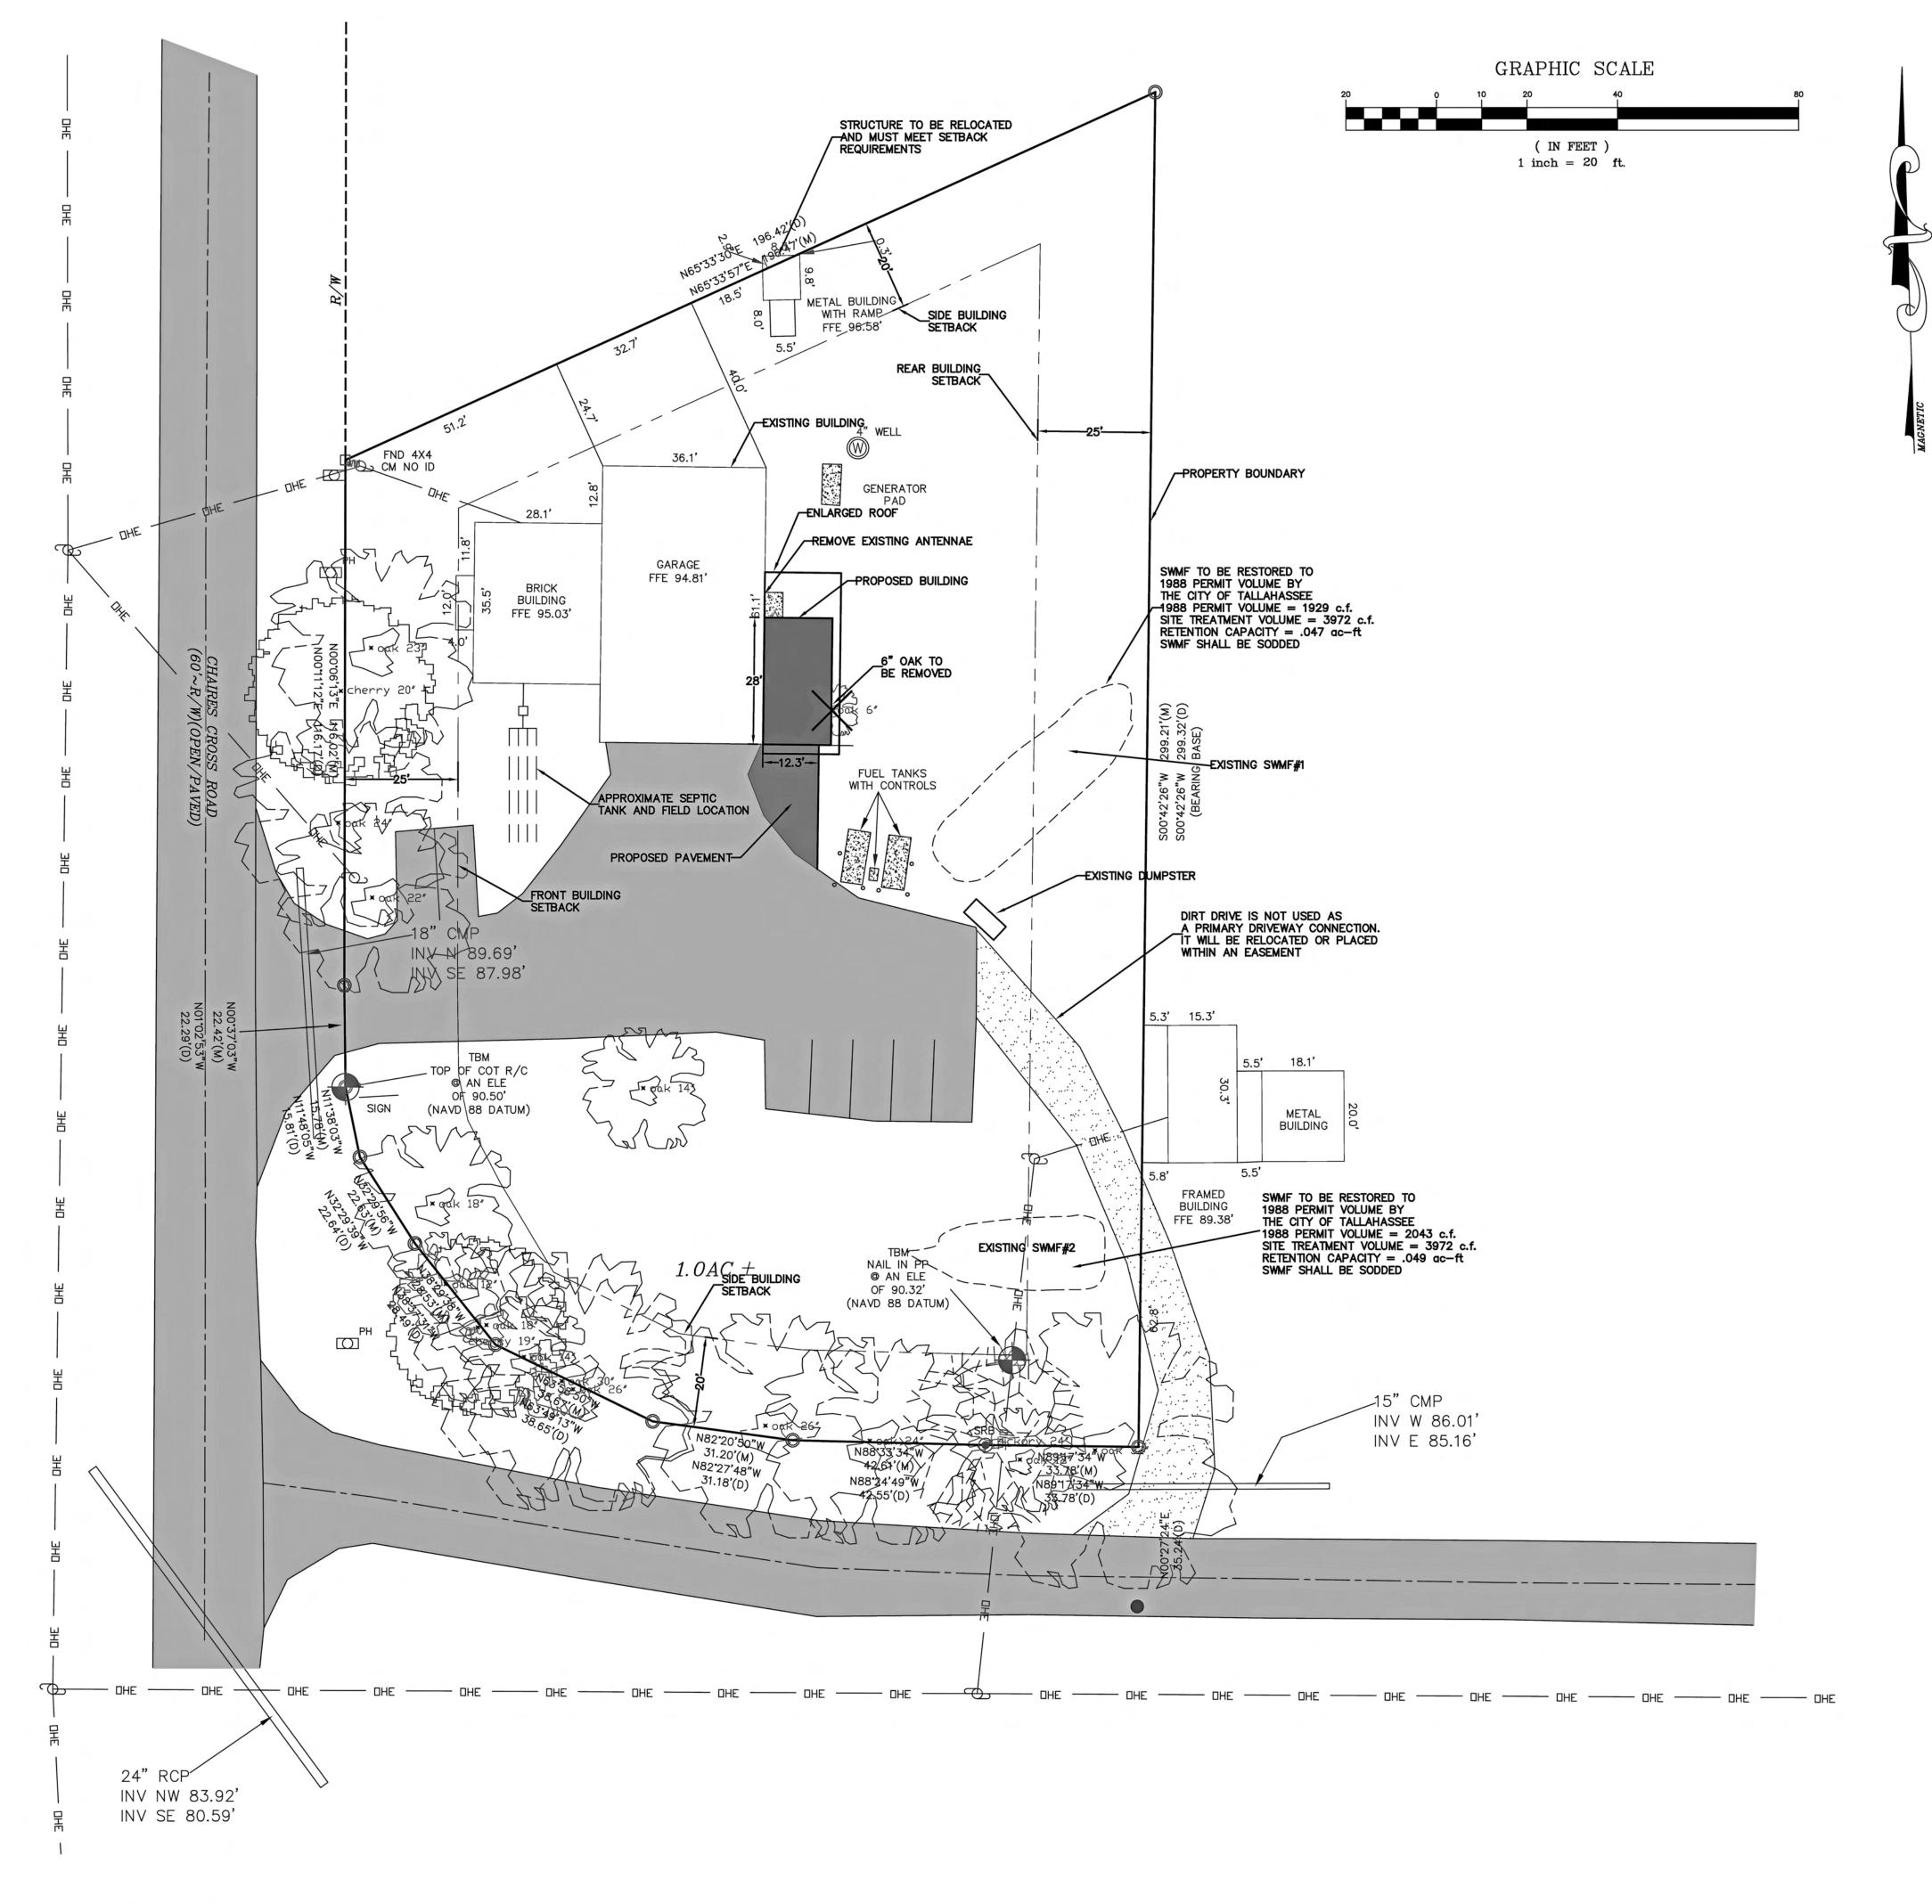

SITE STATISTICS

Project Owner:

City of Tallahassee 300 S. Adam Street Tallahassee, FL 32301

Project Name: Existing Zoning: Existing Land Use: Proposed Use: Parcel ID No.: Physical Address:


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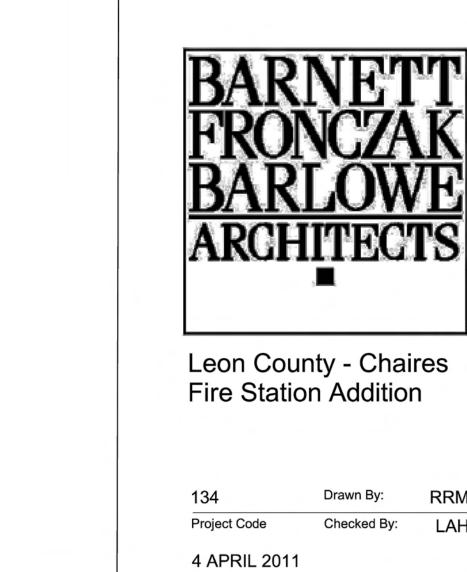
Potable Water Source: TALQUIN Sanitary Sewer Provider: SEPTIC

TABULATION	Square Footage	%
Total Parcel Area: Project Area:	43,568 9,675	100
Existing Building Area: Existing Sidewalk & Conc. Pads: Existing Pavement:	3,251 181 6,777	7.46 0.42 15.55
Existing Impervious Area:	10,209	23.4
Proposed Addtl Building Area and Proposed Enlarged Roof Area: Proposed Addtl Sidewalks: Proposed Addtl Pavement: Less Ex. Conc. Pad under Overhan	650 0 297 g: -23	1.49 0 0.68 0.05
Total Addtl Impervious Area Propos	======== sed 924	2.12
Natural Area	8,110	18.6
Parking Provided Disabled Spaces Total Parking Provided	7 0 7	



C.A. #28124 36 JASPER THOMAS ROAD CRAWFORDVILLE, FL 32327 (850) 926-2593 PHONE (850) 926-9257 FAX



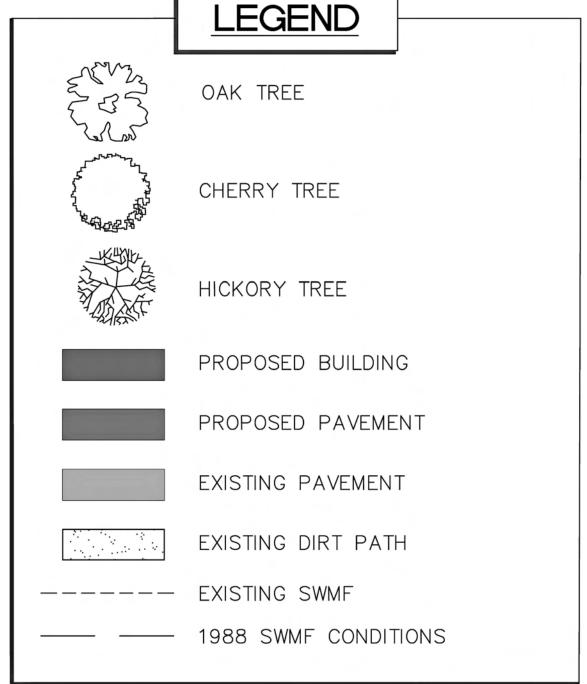


8" COMPACT TO 98% MOD, PROCTOR

12" COMPACT TO 98%

MOD, PROCTOR

134	Drawn By:	RRM
Project Code	Checked By:	LAH
4 APRIL 2011		
Date		
SITE PLA	AN	

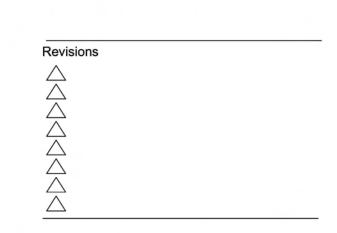

CHAIRES FIRE STATION


TYPICAL PAVEMENT SECTION

SURFACE COURSE - INSTALL 2 1/2" (MINIMUM) OF TYPE S-1 ASPHALTIC CONCRETE

BASE COURSE - LIMEROCK (8" COMPACTED THICKNESS)
WITH PRIME COAT

SUBGRADE - LBR 35 FOR 12" MIN. DEPTH

225 South Adams St, Tallahassee, FL 32301 Phone 850 224-6301 Fax 850 561-6978

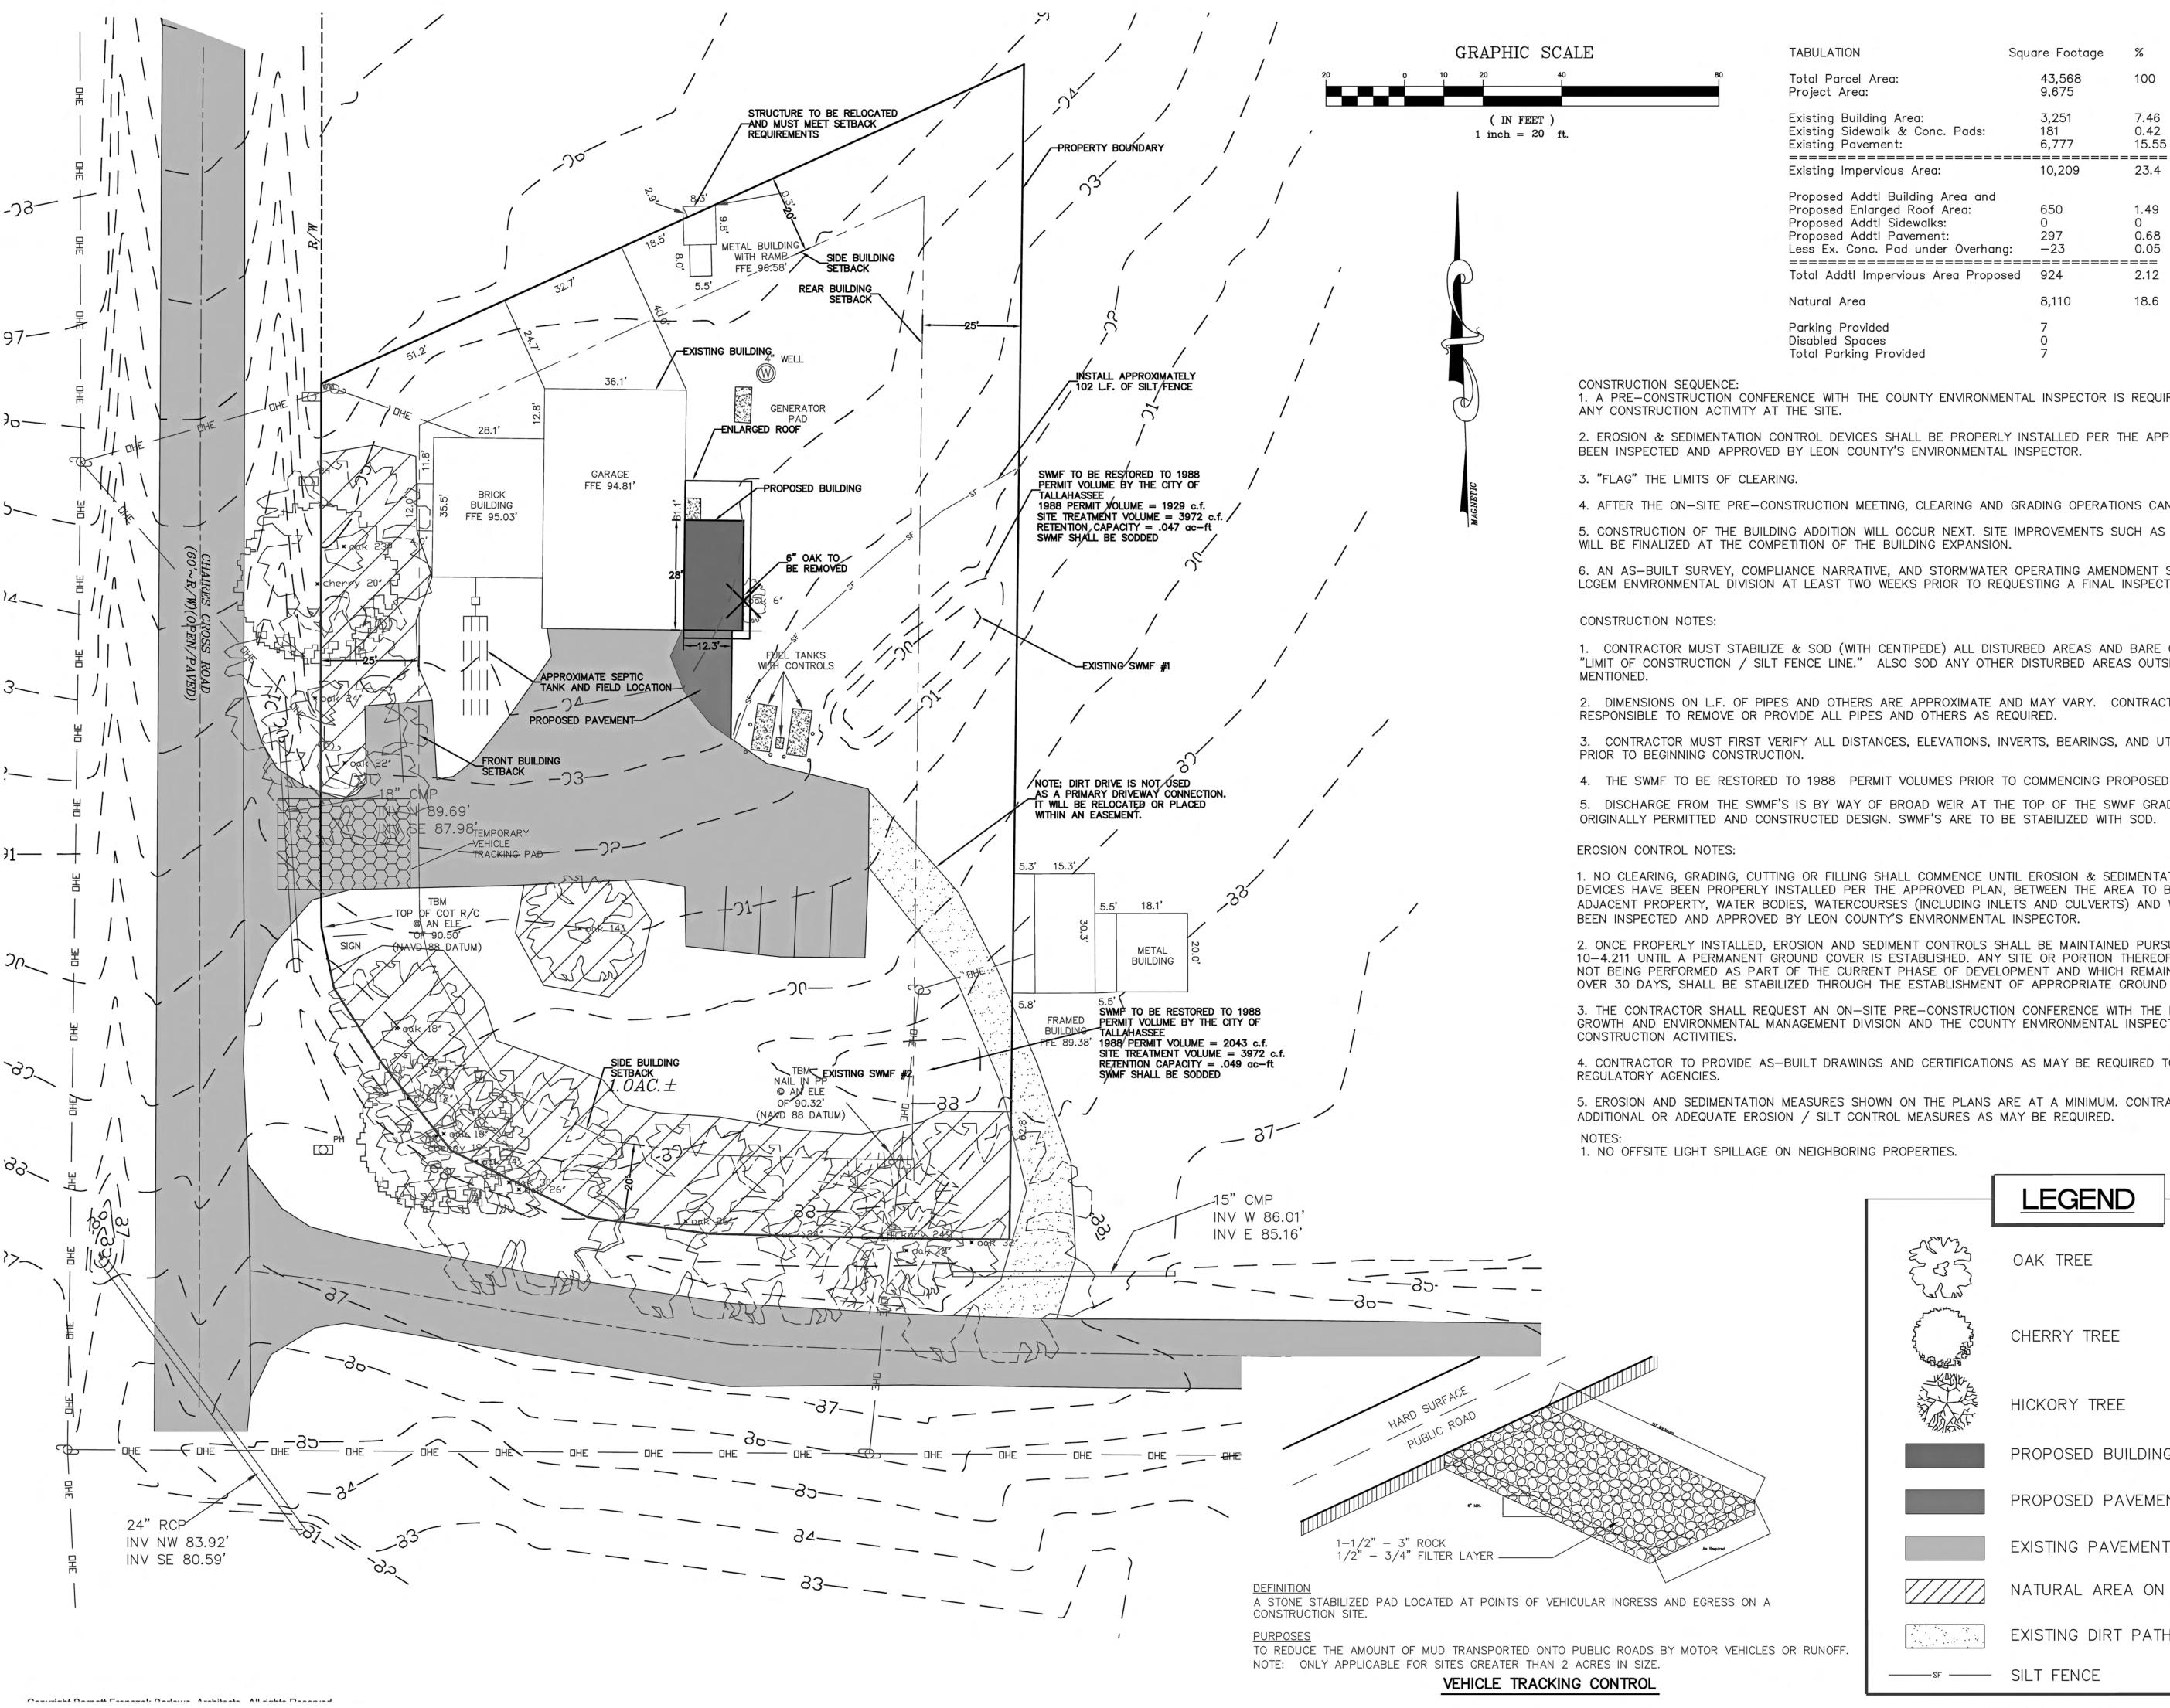

SITE STATISTICS

Project Owner:

City of Tallahassee 300 S. Adam Street Tallahassee, FL 32301

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Potable Water Source: TALQUIN Sanitary Sewer Provider: SEPTIC

1. A PRE-CONSTRUCTION CONFERENCE WITH THE COUNTY ENVIRONMENTAL INSPECTOR IS REQUIRED PRIOR TO BEGINNING

Square Footage

43,568

9,675

181

297

6,777

10,209

0.42

15.55

23.4

0.68

0.05

2.12

18.6

2. EROSION & SEDIMENTATION CONTROL DEVICES SHALL BE PROPERLY INSTALLED PER THE APPROVED PLAN, AND HAVE

- 4. AFTER THE ON-SITE PRE-CONSTRUCTION MEETING, CLEARING AND GRADING OPERATIONS CAN COMMENCE.
- 5. CONSTRUCTION OF THE BUILDING ADDITION WILL OCCUR NEXT. SITE IMPROVEMENTS SUCH AS PAVING OPERATIONS WILL BE FINALIZED AT THE COMPETITION OF THE BUILDING EXPANSION.
- 6. AN AS-BUILT SURVEY, COMPLIANCE NARRATIVE, AND STORMWATER OPERATING AMENDMENT SHALL BE SUBMITTED TO LCGEM ENVIRONMENTAL DIVISION AT LEAST TWO WEEKS PRIOR TO REQUESTING A FINAL INSPECTION.
- 1. CONTRACTOR MUST STABILIZE & SOD (WITH CENTIPEDE) ALL DISTURBED AREAS AND BARE GROUND WITHIN THE "LIMIT OF CONSTRUCTION / SILT FENCE LINE." ALSO SOD ANY OTHER DISTURBED AREAS OUTSIDE THIS LIMIT
- 2. DIMENSIONS ON L.F. OF PIPES AND OTHERS ARE APPROXIMATE AND MAY VARY. CONTRACTOR TO BE
- 3. CONTRACTOR MUST FIRST VERIFY ALL DISTANCES, ELEVATIONS, INVERTS, BEARINGS, AND UTILITY LOCATIONS
- 4. THE SWMF TO BE RESTORED TO 1988 PERMIT VOLUMES PRIOR TO COMMENCING PROPOSED IMPROVEMENTS.
- 5. DISCHARGE FROM THE SWMF'S IS BY WAY OF BROAD WEIR AT THE TOP OF THE SWMF GRADE CONSISTENT WITH ORIGINALLY PERMITTED AND CONSTRUCTED DESIGN. SWMF'S ARE TO BE STABILIZED WITH SOD.
- 1. NO CLEARING, GRADING, CUTTING OR FILLING SHALL COMMENCE UNTIL EROSION & SEDIMENTATION CONTROL DEVICES HAVE BEEN PROPERLY INSTALLED PER THE APPROVED PLAN, BETWEEN THE AREA TO BE DISTURBED AND ADJACENT PROPERTY, WATER BODIES, WATERCOURSES (INCLUDING INLETS AND CULVERTS) AND WETLANDS AND HAVE
- 2. ONCE PROPERLY INSTALLED, EROSION AND SEDIMENT CONTROLS SHALL BE MAINTAINED PURSUANT TO SECTION 10-4.211 UNTIL A PERMANENT GROUND COVER IS ESTABLISHED. ANY SITE OR PORTION THEREOF WHERE WORK IS NOT BEING PERFORMED AS PART OF THE CURRENT PHASE OF DEVELOPMENT AND WHICH REMAINS CLEARED FOR OVER 30 DAYS, SHALL BE STABILIZED THROUGH THE ESTABLISHMENT OF APPROPRIATE GROUND COVER.
- 3. THE CONTRACTOR SHALL REQUEST AN ON-SITE PRE-CONSTRUCTION CONFERENCE WITH THE LEON COUNTY GROWTH AND ENVIRONMENTAL MANAGEMENT DIVISION AND THE COUNTY ENVIRONMENTAL INSPECTOR PRIOR TO ANY
- 4. CONTRACTOR TO PROVIDE AS-BUILT DRAWINGS AND CERTIFICATIONS AS MAY BE REQUIRED TO THE OWNER OR
- 5. EROSION AND SEDIMENTATION MEASURES SHOWN ON THE PLANS ARE AT A MINIMUM. CONTRACTOR TO PROVIDE ADDITIONAL OR ADEQUATE EROSION / SILT CONTROL MEASURES AS MAY BE REQUIRED.

LEGEND

OAK TREE

CHERRY TREE

HICKORY TREE

PROPOSED BUILDING


PROPOSED PAVEMENT

EXISTING PAVEMENT

EXISTING DIRT PATH

NATURAL AREA ON SITE

1. NO OFFSITE LIGHT SPILLAGE ON NEIGHBORING PROPERTIES.

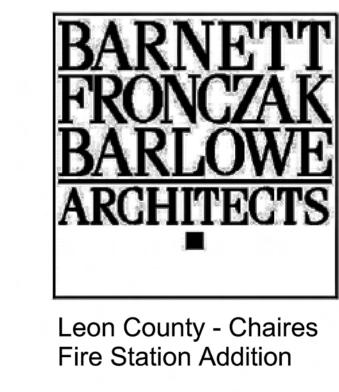


C.A. #28124

36 JASPER THOMAS ROAD CRAWFORDVILLE, FL 32327

(850) 926-2593 PHONE


(850) 926-9257 FAX


2010134	Drawn By:	RRM
Project Code	Checked By:	LAH
4 APRIL 2011		
Date		
GRADING	PLAN	
<u> </u>		
Revisions		

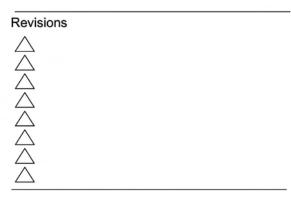


CHAIRES FIRE STATION


Phone 850 224-6301 Fax 850 561-6978

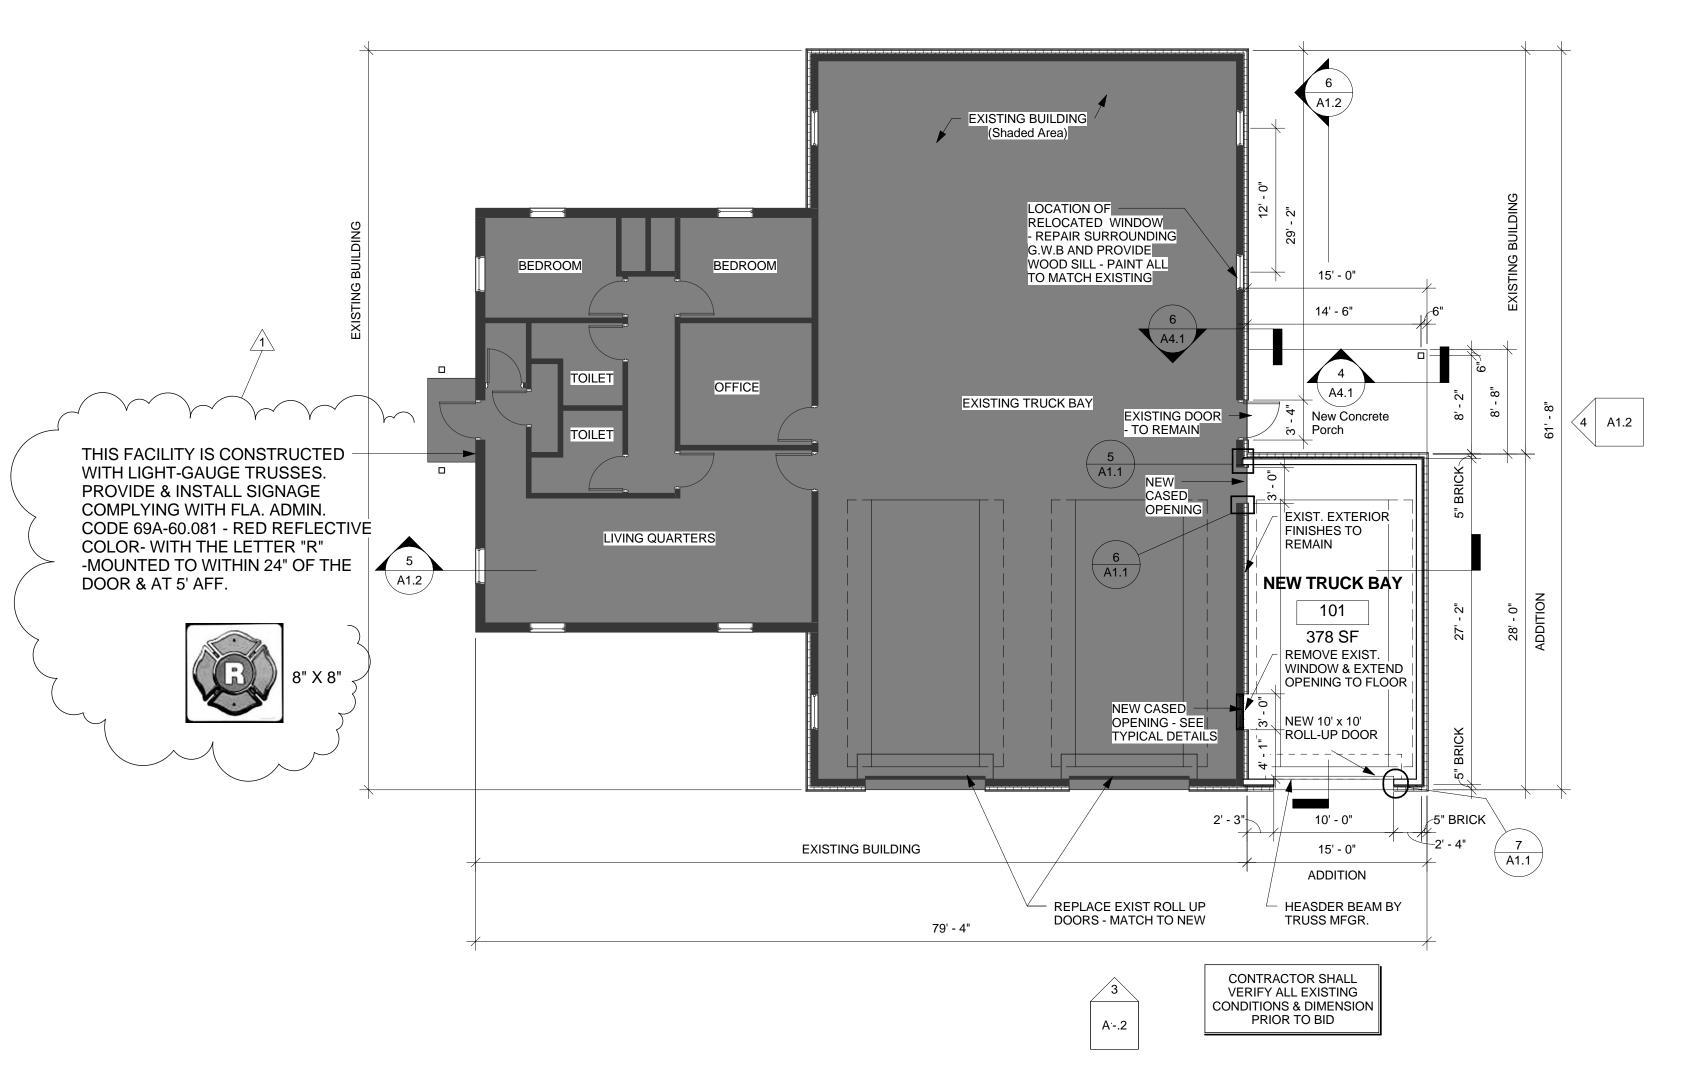

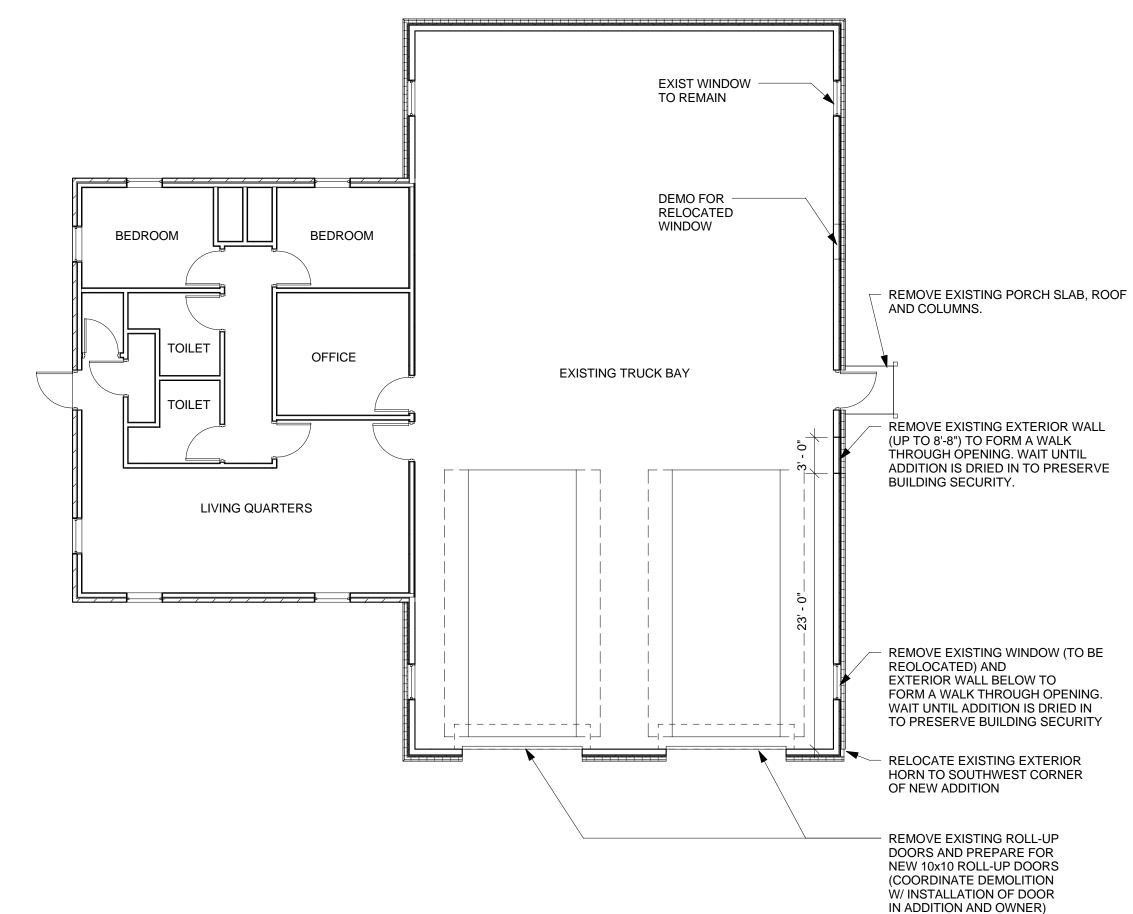




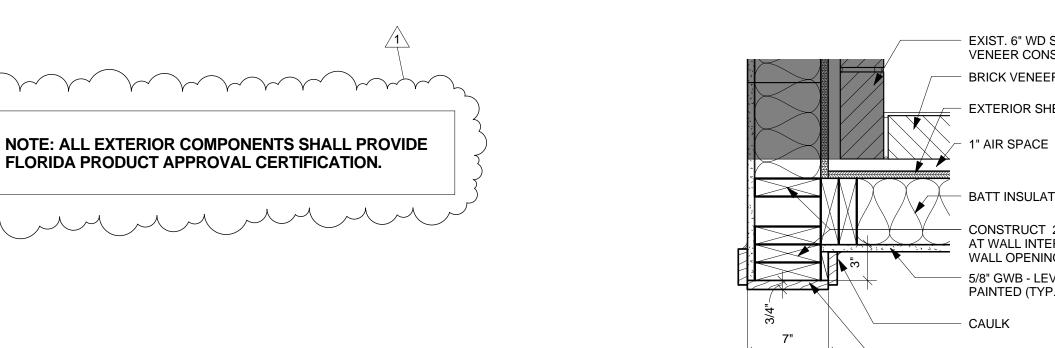


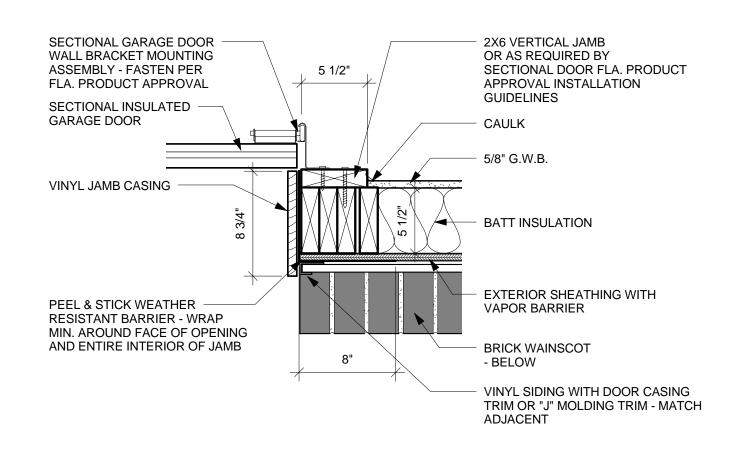

Section Garage Door - Typical Detail A1.1 1 1/2" = 1'-0"

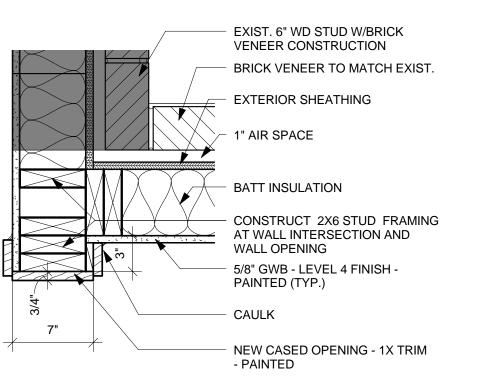





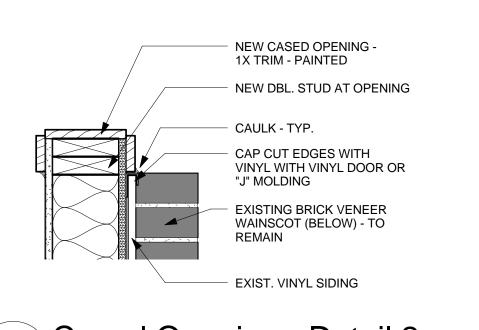

6 Cased Opening - Detail 2 A1.1 1 1/2" = 1'-0"

Demolition Floor Plan

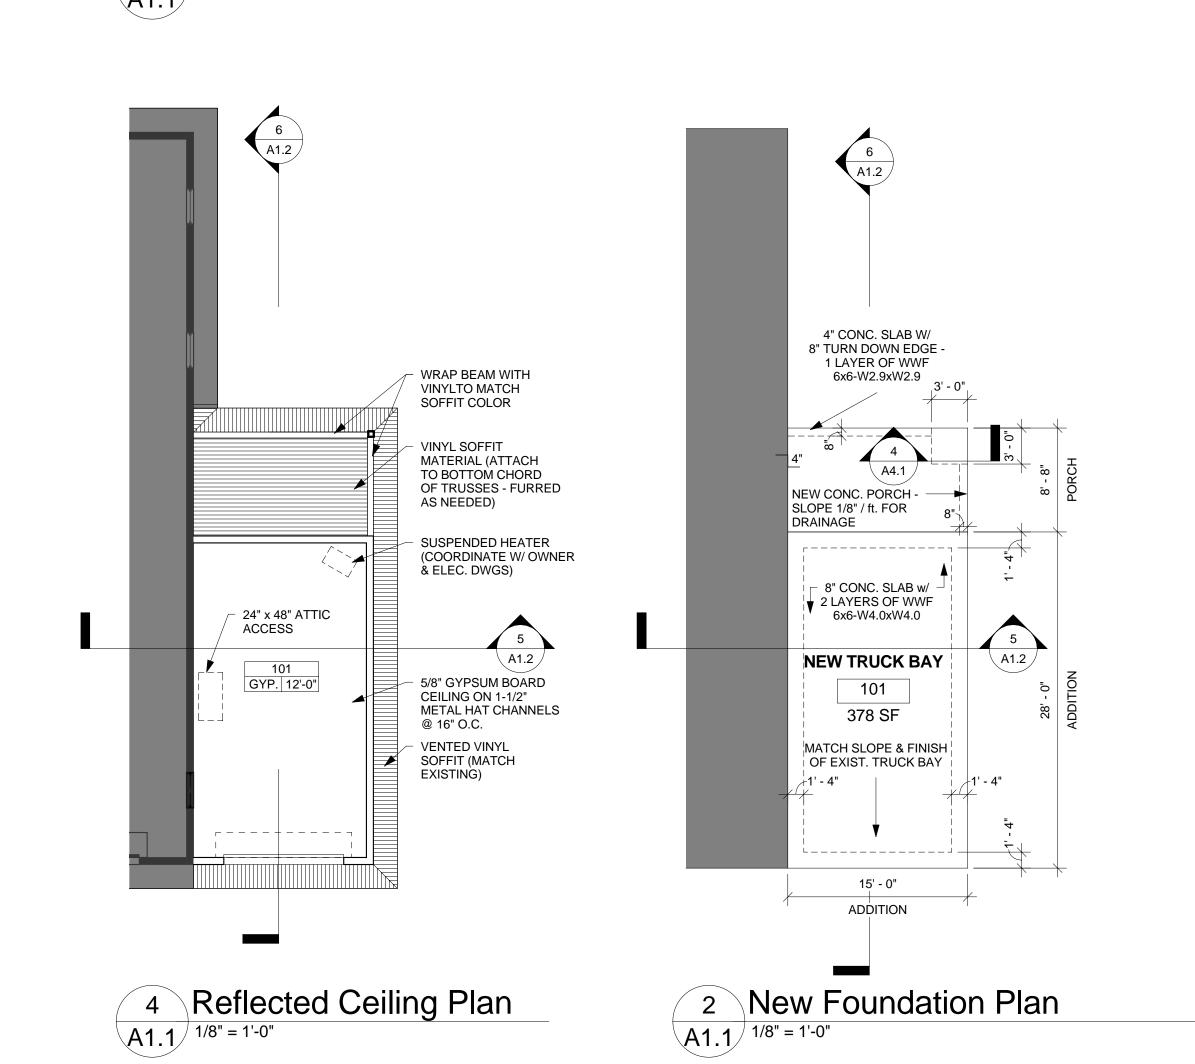

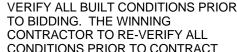

DEMOLITION NOTES

- 1. DEMOLITION CONTRACTOR SHALL VERIFY ALL BUILT CONDITIONS PRIOR TO BIDDING. THE WINNING CONTRACTOR TO RE-VERIFY ALL CONDITIONS PRIOR TO CONTRACT AND COMMENCEMENT OF WORK.
- 2. PROTECT ALL NON-DEMOLITION AREAS FROM DEMOLITION RELATED DAMAGE (INCLUDING DUST).
- 3. PROTECT ALL NON-DEMOLITION AREAS FROM THE ELEMENTS, INCLUDING MAINTAINING A WEATHERTIGHT ENVELOPE AT ALL TIMES IN THE EXISTING FACILITY.
- 4. CAP ALL UNUSED UTILITIES OR REROUTE ALL IN-SERVICE UTILITIES PER CIVIL AND/OR MEP ENGINEERS. REFERENCE SPECIFIC ENGINEER DRAWINGS FOR ADDITIONAL

INFORMATION.

- 5. REMOVE AND SALVAGE ALL ITEM AS REQUESTED BY THE COUNTY OR ARCHITECT/ENGINEER ON THESE PLANS. ANY AND ALL SALVAGED ITEMS SHALL BE STOCKPILED/STORED IN REMOVED OR RECONDITIONED STATE, OR DELIVERED TO OWNER AS SPECIFIED, UNTIL RE-USED ON SITE IF APPLICABLE.
- 6. CONSULT STRUCTURAL ENGINEER FOR QUESTIONS REGARDING THE SEQUENCE OF THE DEMOLITION OF STRUCTURAL ITEMS.
- 7. KEEP THE SITE CLEAN AND ORDERLY.
- 8. CONTRACTOR IS TO LIMIT THE LOCATION OF CONSTRUCTION VEHICLES, DEBRIS, MATERIAL STORAGE, LAY-OUT AREAS, ETC. TO LOCATIONS SPECIFIED BY OWNER.
- 9. CONTRACTOR IS RESPONSIBLE FOR FOLLOWING SPECIFICATIONS GOVERNING CONSTRUCTION ACTIVITIES FOUND IN SECTION 011000-SUMMARY.
- 10. CONTRACTOR IS RESPONSIBLE FOR ALL DEMOLITION BARRICADES, FENCING, ETC. SEPARATING STAFF FROM ALL CONSTRUCTION ACTIVITIES INCLUDING DUST, ODOR AND NOISE.
- 11. CONTRACTOR IS SOLELY RESPONSIBLE FOR MAINTAINING SAFE CONSTRUCTION ZONE ENVIRONMENT FOR STAFF.



Leon County - Chaires Fire Station Addition

11000	Drawn By:	JH
Project Code	Checked By:	RRI
14 April 2011		
Date		
Constructi	_	
Document	S	

Revisions	
<u>1</u> 06/20/2011	Code Comments
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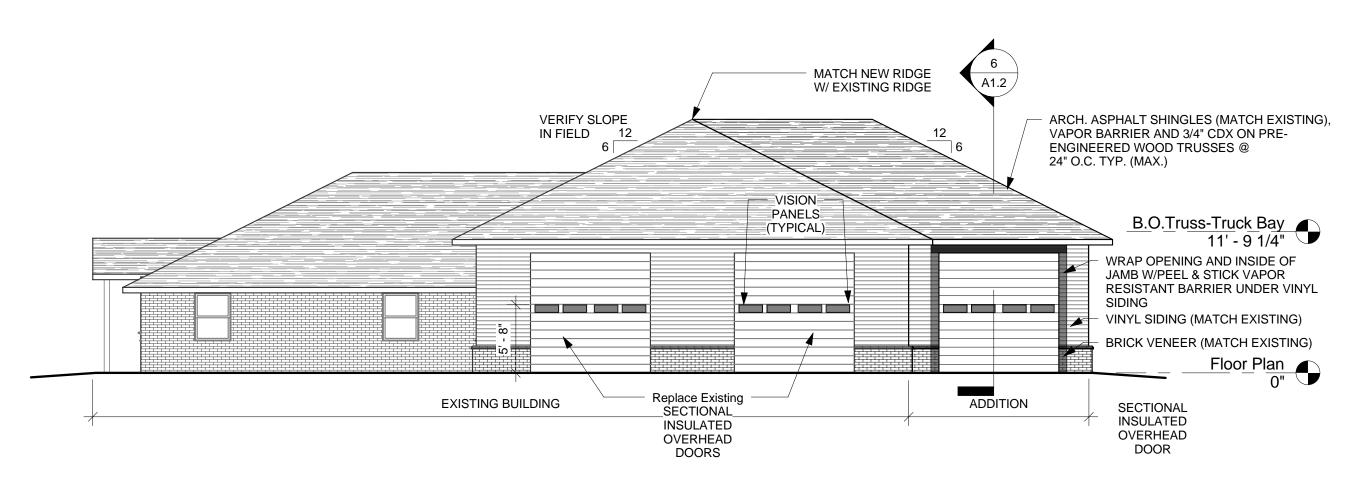
Demolition Plan, New Foundation Plan, New Floor Plan and New Reflected Ceiling Plan

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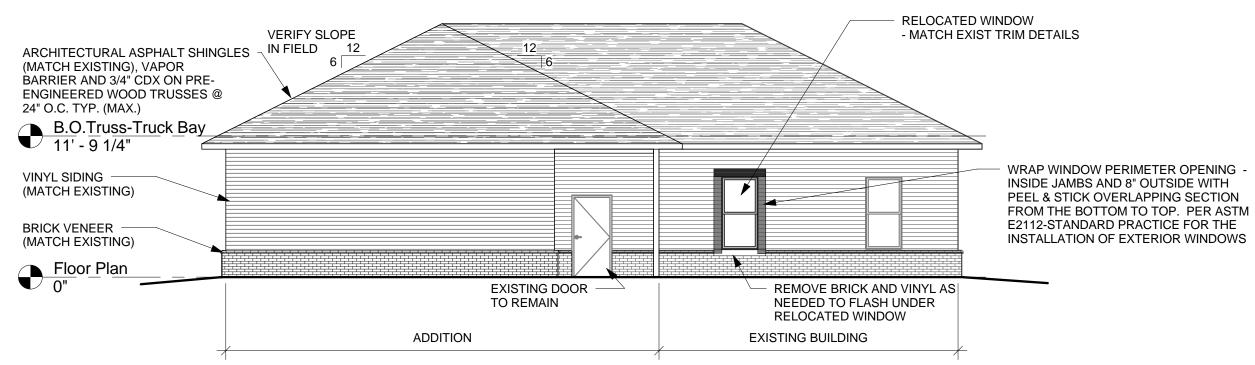
225 South Adams St, Tallahassee, FL 32301

Fax 850 561-6978


Phone 850 224-6301





3 West - New Building Elevation
A1.2 1/8" = 1'-0"



4 South - New Building Elevation A1.2 1/8" = 1'-0"

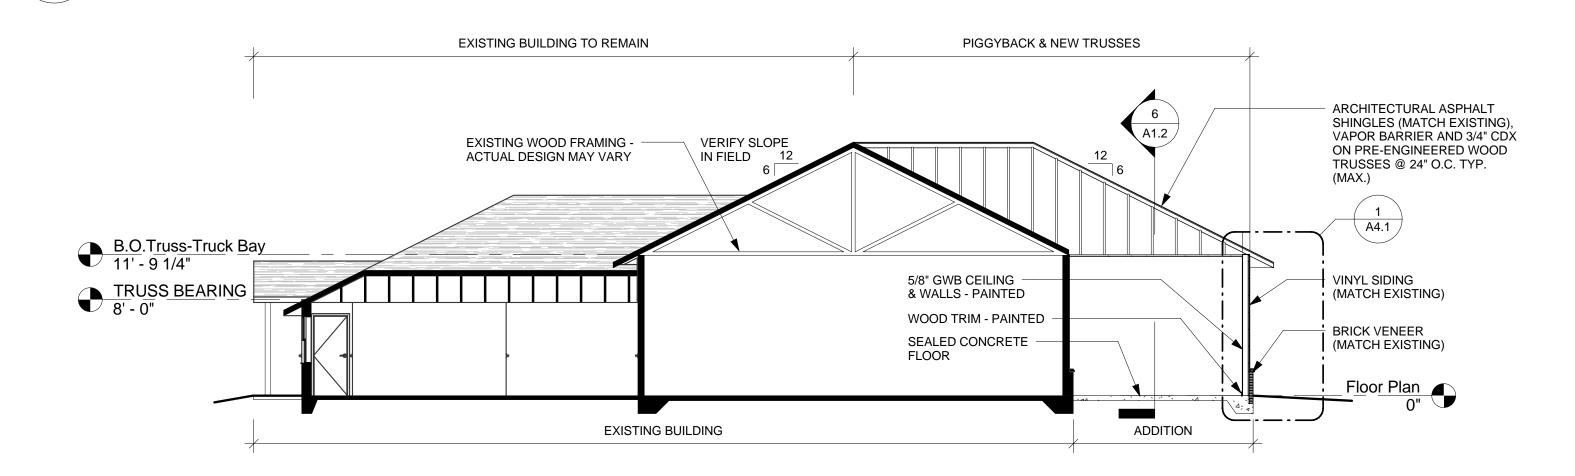


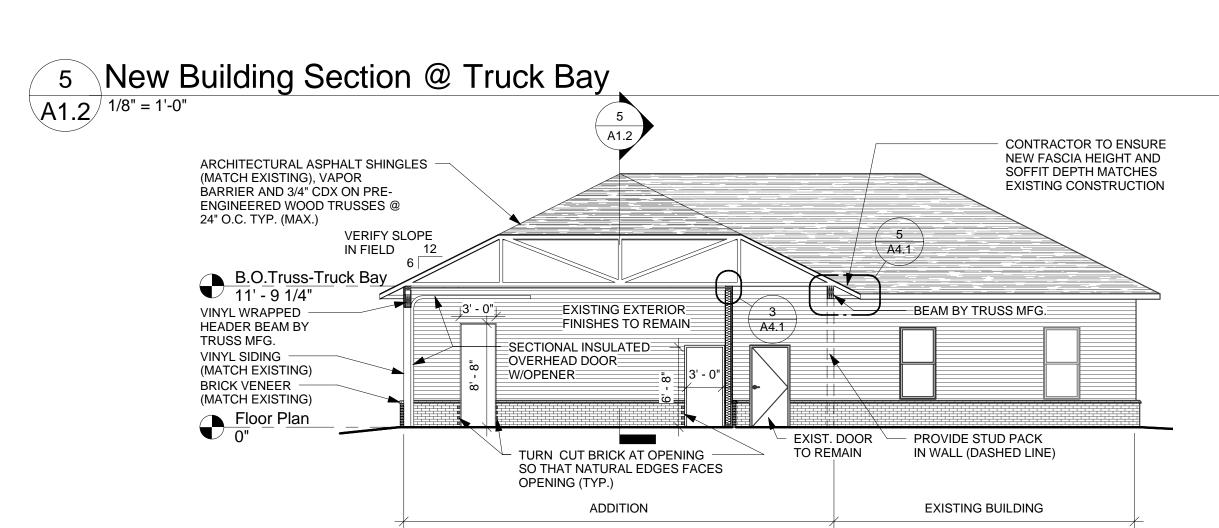

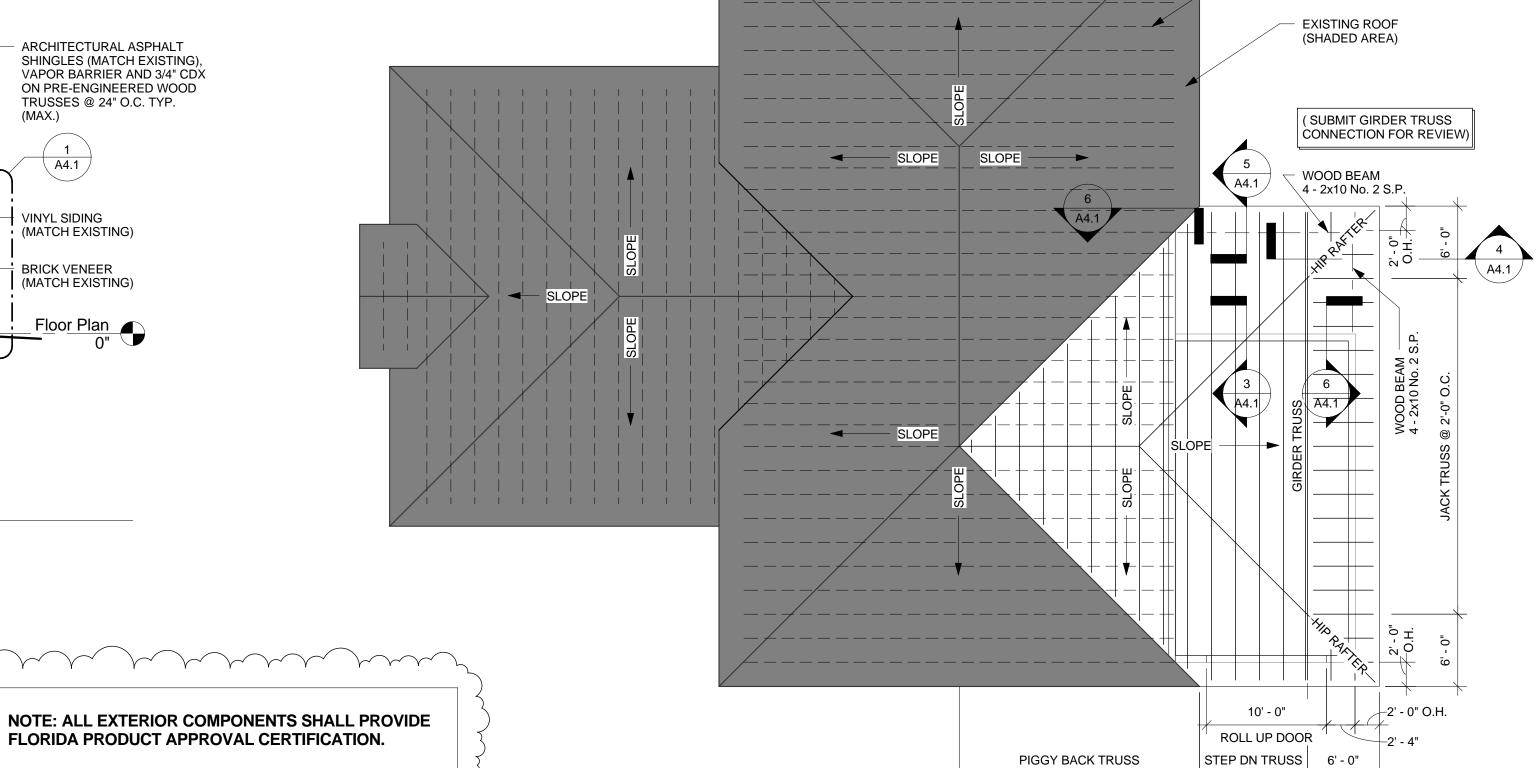

@ 2'-0" O.C. (TYP.)

@ 2'-0" O.C. (TYP.)

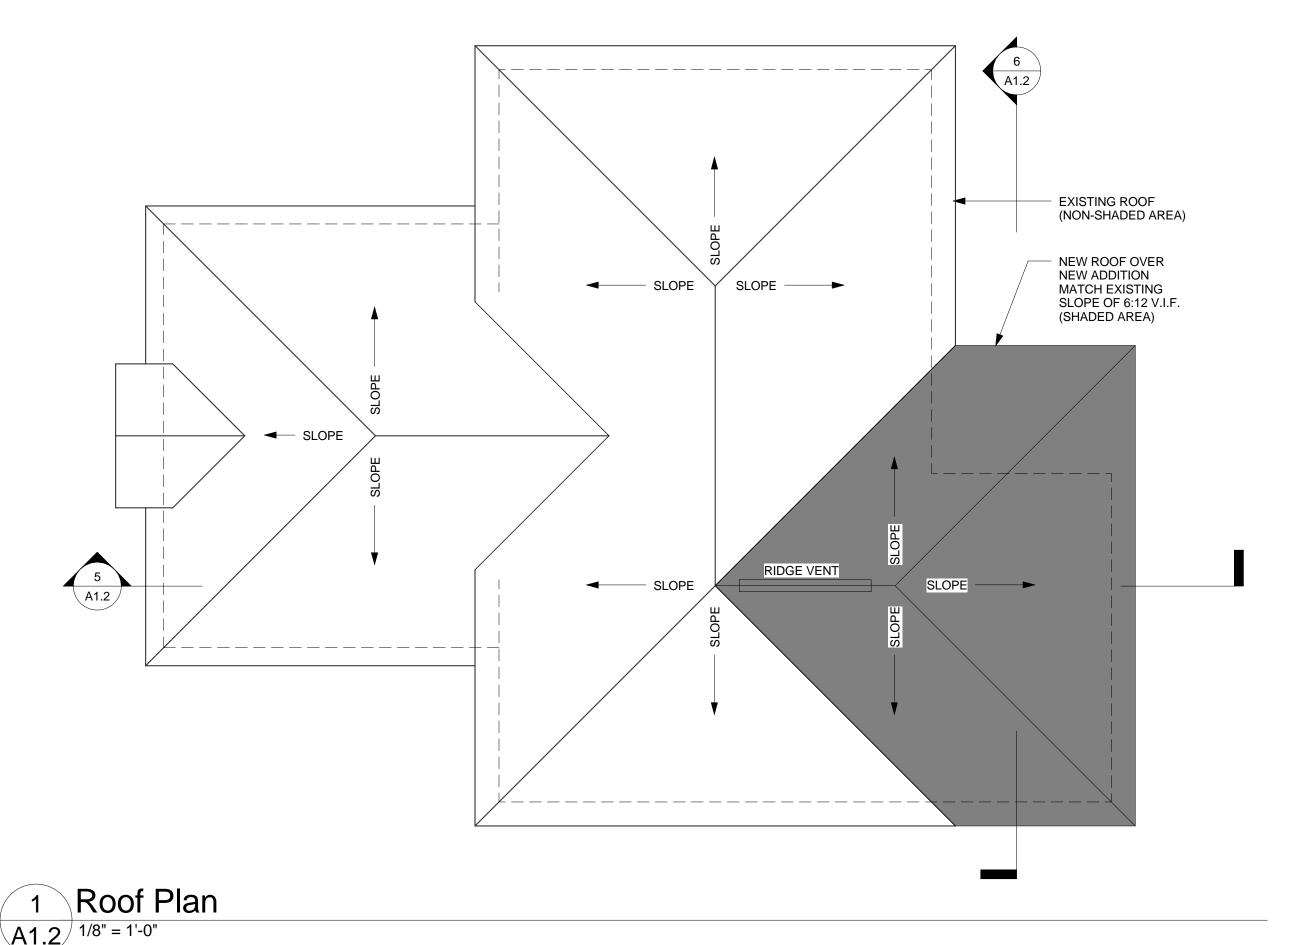

EXISTING ROOF FRAMING (DASHED

Leon County - Chaires Fire Station Addition

11000 Drawn By: JH2 Checked By: RRB Project Code 14 April 2011

Construction Documents


Revisions 06/20/2011

Roof Plans, Building Elevations and **Building Sections**


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Fax 850 561-6978


2 Roof Framing Plan
A1.2 1/8" = 1'-0"

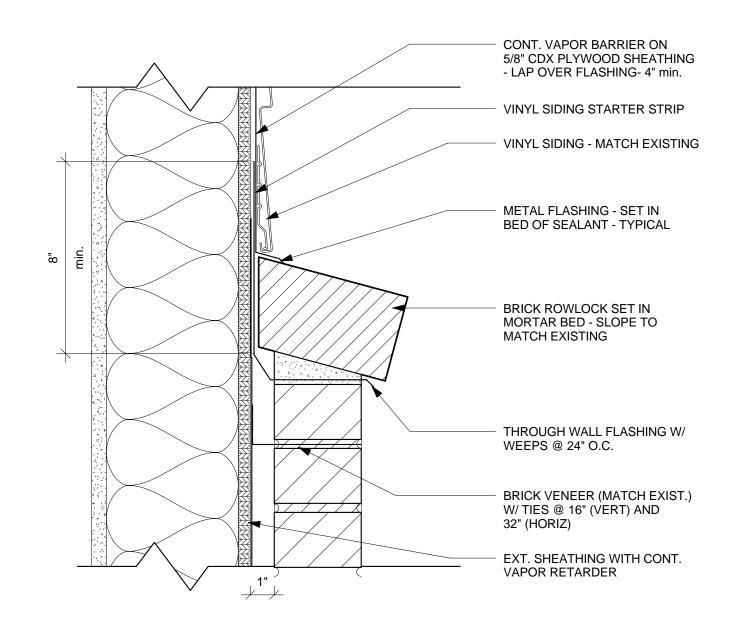


7 Brick Sill Detail

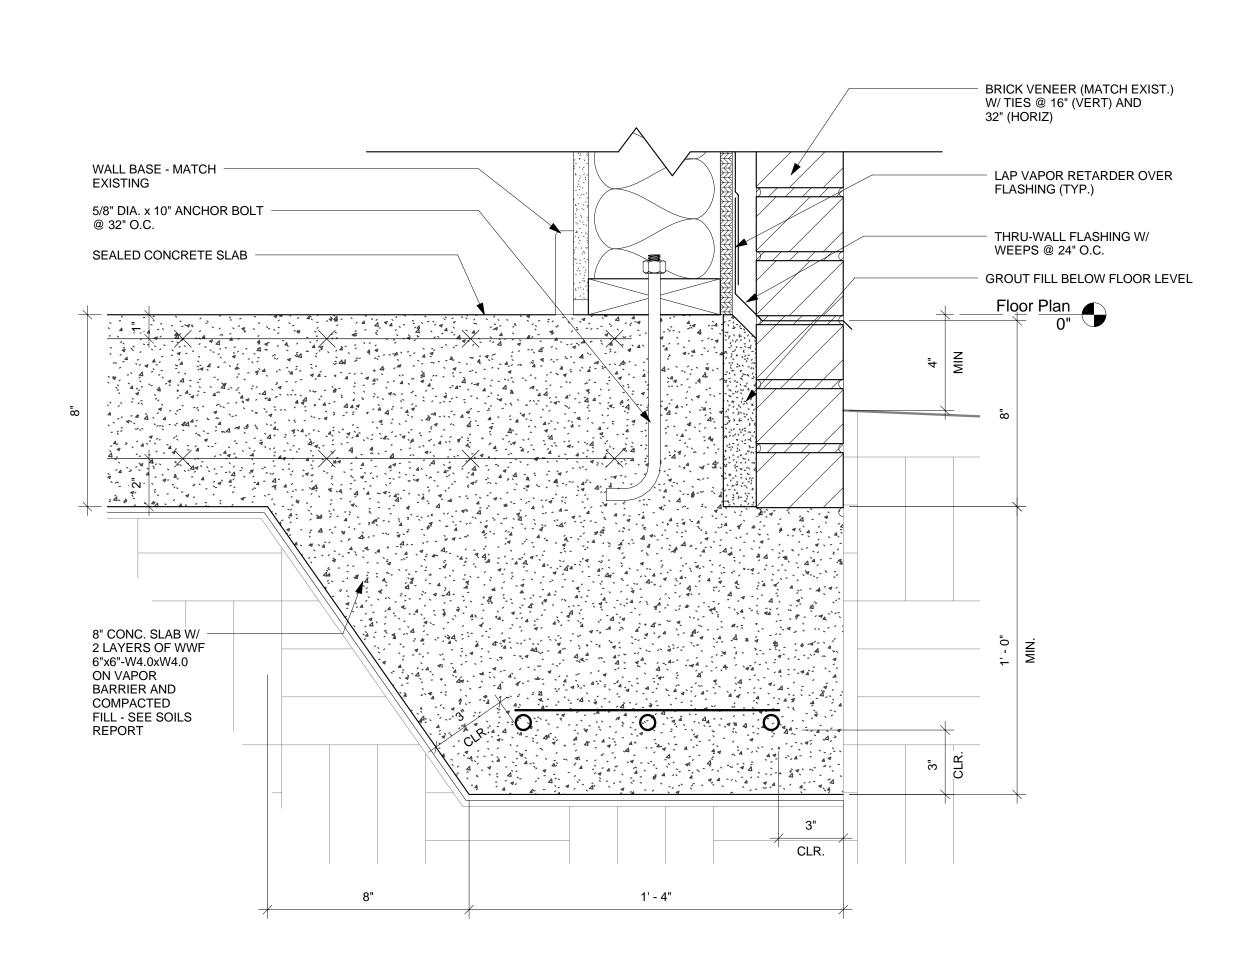

8 Sill Detail
A4.1 3" = 1'-0"
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4 Beam Section & Connection @ Porch

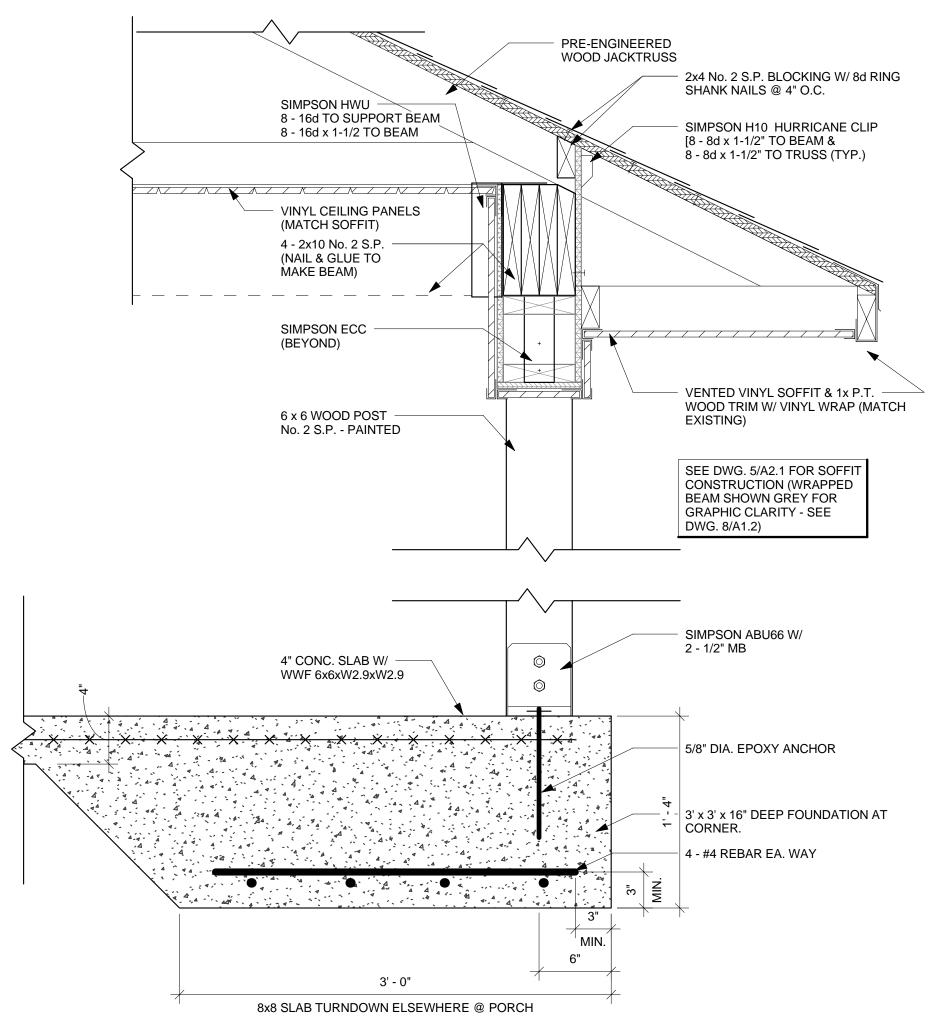

5 Typical Beam & Soffit @ Porch A4.1 11/2" = 1'-0" 8d RIM SHANK NAILS @ 4" INTO BLOCKING 8d RIM SHANK NAILS @ 6" INTO TRUSS 2x4 No. 2 S.P. EXISTING PRE-ENGINEERED WOOD BLOCKING SIMPSON HUCQ610-SDS W/ 12 - SDS 1/4 x 2-1/2 TO - 1/2" PLYWOOD DECK UP TO STUDS & 6 - SDS 1/4 x 2-1/2 SIMPSON H10 HURRICANE CLIP ROOF DECK (EVERY OTHER 8 - 8d x 1-1/2" TO BEAM & 8 - 8d x 1-1/2" TO TRUSS (TYP.) TO BEAM SPACE) VINYL CEILING PANELS (2) 2x6 TOP PLATE (TYP.) (MATCH SOFFIT) 4 - 2x10 No. 2 S.P. (NAIL & GLUE TO MAKE BEAM) WRAP BEAM TO 5/8" GYP. BD. CEILING MATCH SOFFIT COLOR ON 1-1/2" MTL. HAT CHANNELS @ 16" O.C. VAPOR BARRIER ON STUD PACK @ BEAM 1/2" EXTERIOR SHEATHING INTERSECTION LAP SIDING - MATCH EXISTING 2x6 WOOD STUDS @ 16" O.C. & R-13 FIBERGLASS BATT INSULATION (MIN.) Beam Connection @ Wall 5/8" GYP. BD.

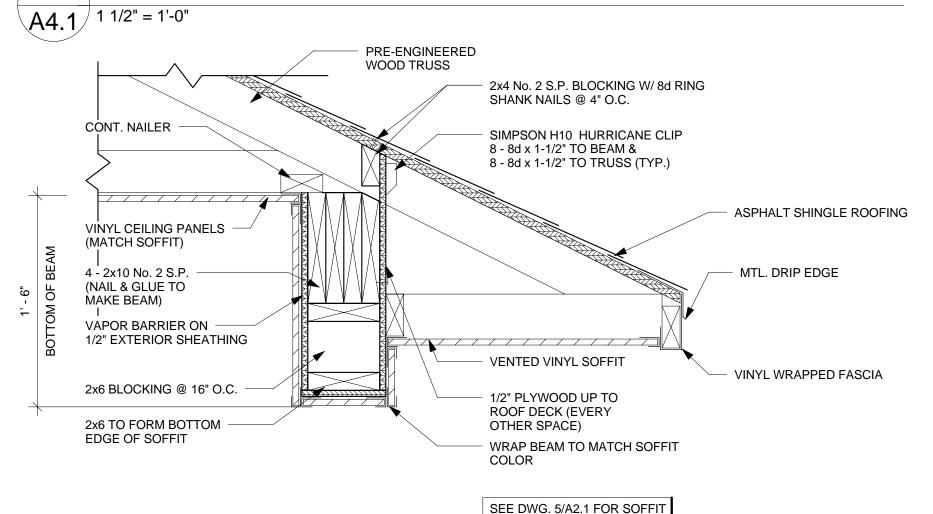EXISTING) ON 3/4" CDX R-30 FIBERGLASS PRE-ENGINEERED WOOD TRUSSES @ **BATT INSULATION -**24" O.C. W/ SIMPSON H10 HURRICANE ALLOW FOR AIR CLIP [8 - 8d x 1-1/2" TO PLATE & 8 - 8d x FLOW AT ROOF 1-1/2" TO TRUSS (TYP.) DECK CONT. NAILER B.O.Truss-Truck Bay 11' - 9 1/4" CONTRACTOR TO ENSURE NEW FASCIA HEIGHT AND 5/8" GYP. BD. CEILING SOFFIT DEPTH MATCHES ON 1-1/2" MTL. HAT **EXISTING CONSTRUCTION** CHANNELS @ 16" O.C. MTL DRIP EDGE 2x P.T. WD FASCIA W/ VINYL (2) 2x6 TOP PLATE (TYP.) WRAP (MATCH EXISTING) **VENTED VINYL SOFFIT** TYP. EACH STUD: VINYL SIDING- INSTALL PER MANUFACTURER 2 - SIMPSON SSP CONNECTOR STANDARD DETAILS (1 EACH SIDE OF STUD) W/ 4 - 10d NAILS TO STUD AND 3 - 10d NAILS TO TOP PLATE VINYL SIDING - MATCH EXISTING CONT. VAPOR BARRIER ON 5/8" CDX PLYWOOD SHEATHING 2x6 WOOD STUDS @ 16" O.C. & R-13 FIBERGLASS BATT INSULATION (MIN.) BRICK ROWLOCK SET IN MORTAR BED - SLOPE TO 5/8" GYP. BD. MATCH EXISTING 1/2" DIA. ANCHOR BOLT TYP. EACH STUD: @ 24" O.C. 2 - SIMPSON SSP CONNECTOR (1 EACH SIDE OF STUD) W/ WALL BASE 4 - 10d NAILS TO STUD AND (MATCH 1 - 10d NAIL TO BOTTOM PLATE EXISTING) 8" CONC. SLAB W/ 2 LAYERS OF WWF 6"x6"-W4.0xW4.0 Floor Plan ON VAPOR SLOPE PER CIVIL DWGS. **BARRIER AND** COMPACTED FILL - SEE SOILS REPORT 3 - #5 REBAR (CONT.) W/ #3 REBAR @ 16" 8" 1' - 4"

ASPHALT SHINGLES (MATCH

1 Typical Wall Section @ Truck Bay

NOTE: ALL EXTERIOR COMPONENTS SHALL PROVIDE FLORIDA PRODUCT APPROVAL CERTIFICATION UPON REQUEST


3/4" CDX W/ VAPOR BARRIER

PIGGYBACK TRUSS

1 - SIMPSON VTCR CLIP @ EA. INTERSECTION OF A NEW PIGGYBACK TRUSS & EXISTING TRUSS & EXISTING TRUSS & SHEATHING

New Piggy Back Truss to Existing Roof

A4.1 1 1/2" = 1'-0"

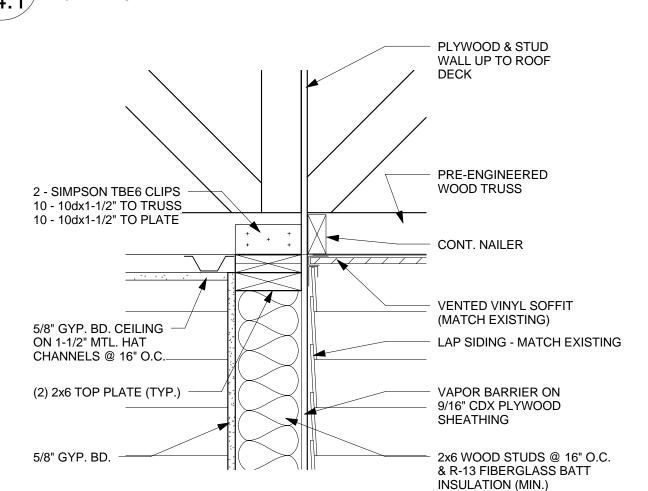

3 Wall Section @ Porch
A4.1 1 1/2" = 1'-0"

FRONCZAK
BARLOWE
ARCHITECTS

Leon County - Chaires

Fire Station Addition

11000 Drawn By: JH
Project Code Checked By: RRI

14 April 2011

Date

Construction

Construction
Documents

Wall Sections and Details


OPTION 2

Phone 850 224-6301


Tallahassee Florida


225 South Adams St, Tallahassee, FL 32301

Fax 850 561-6978

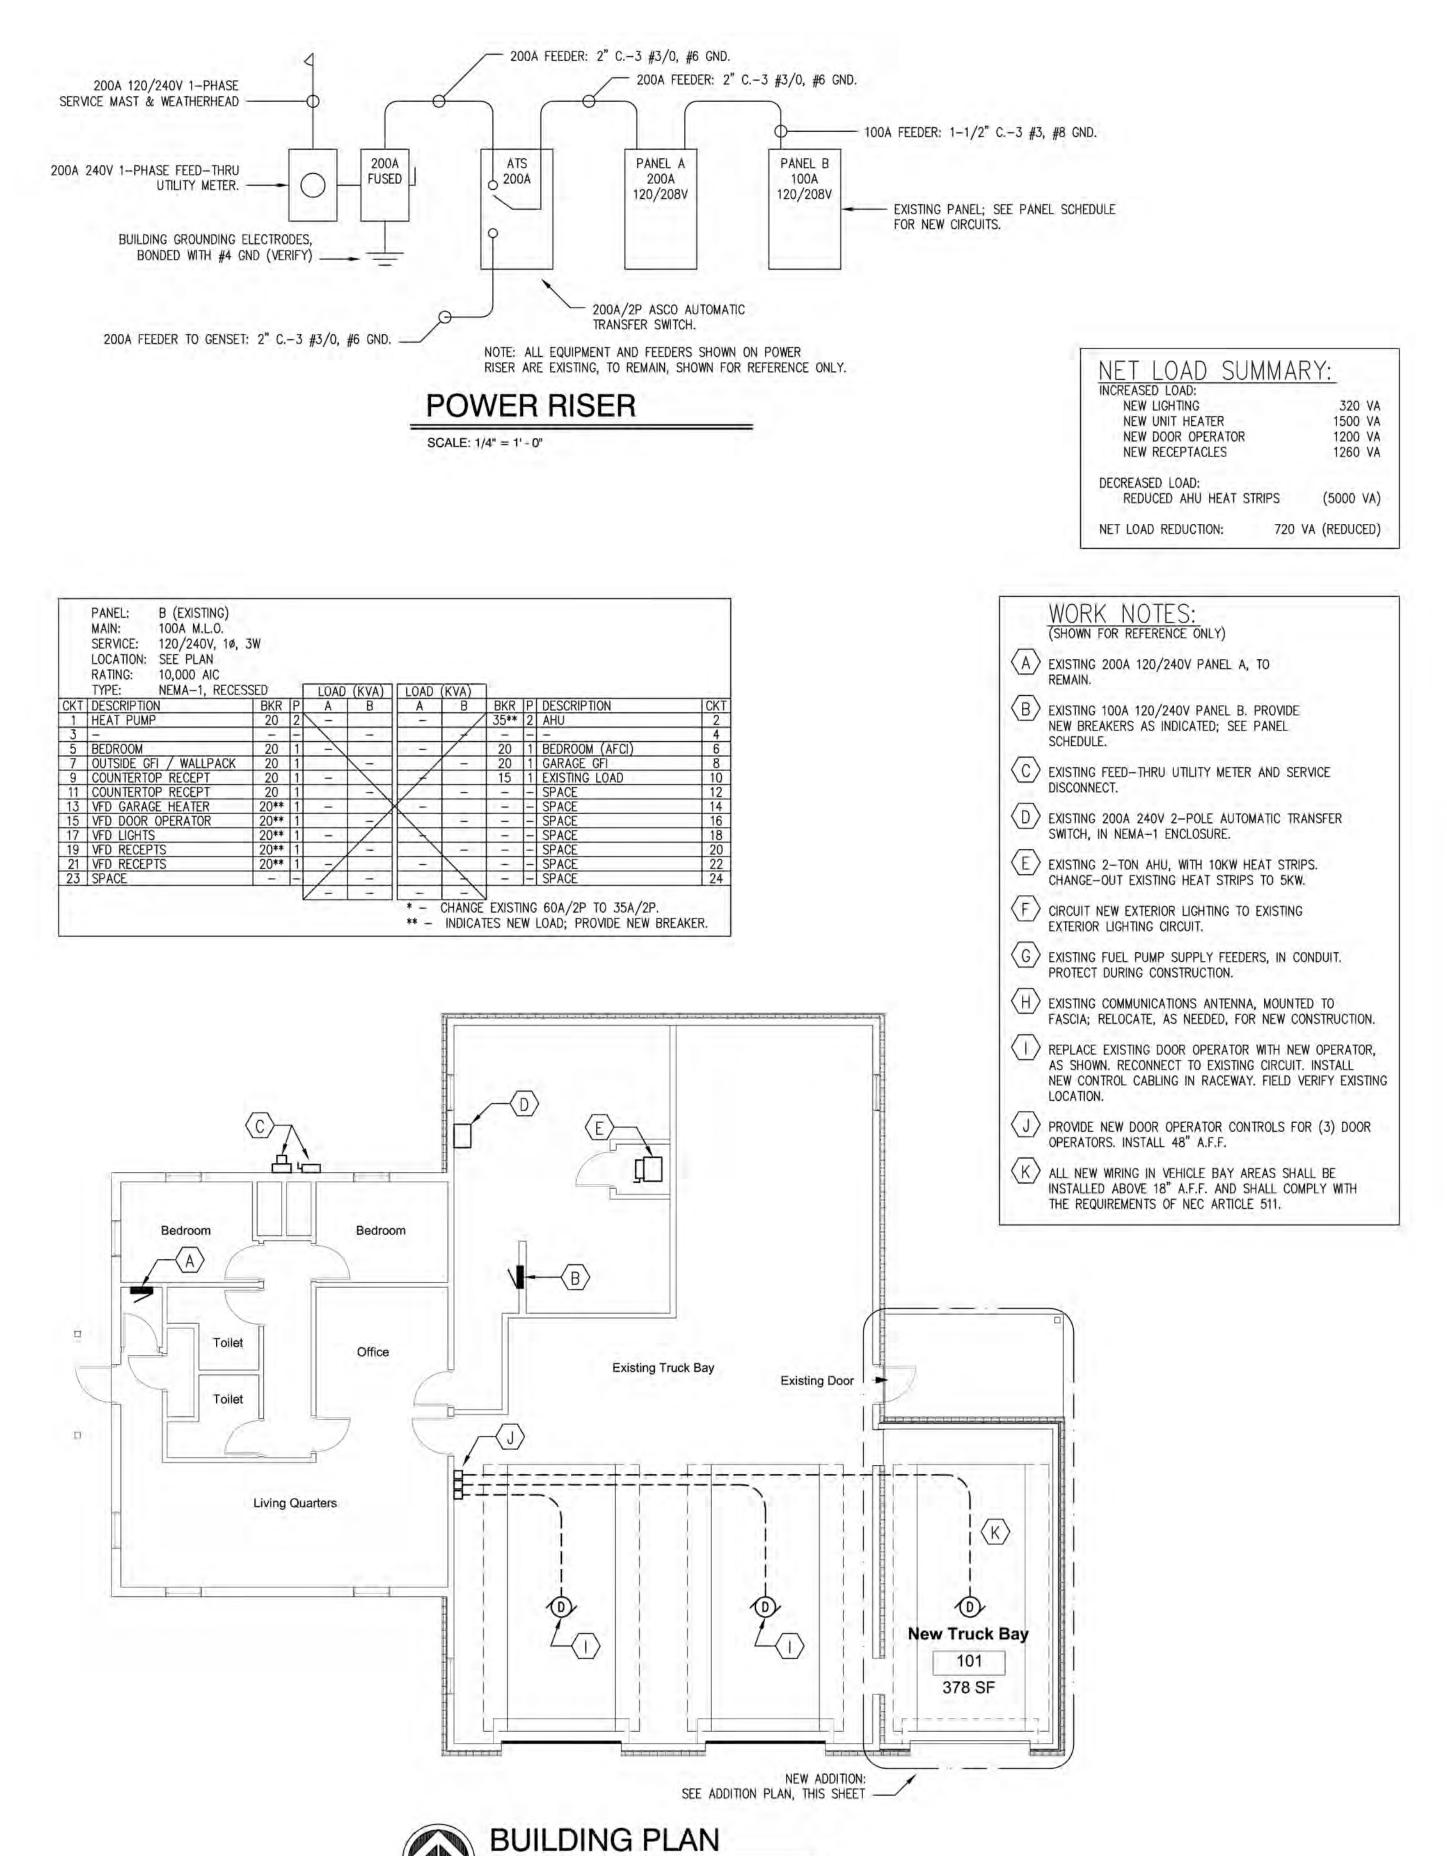

SCALE: 1/8" = 1' - 0"

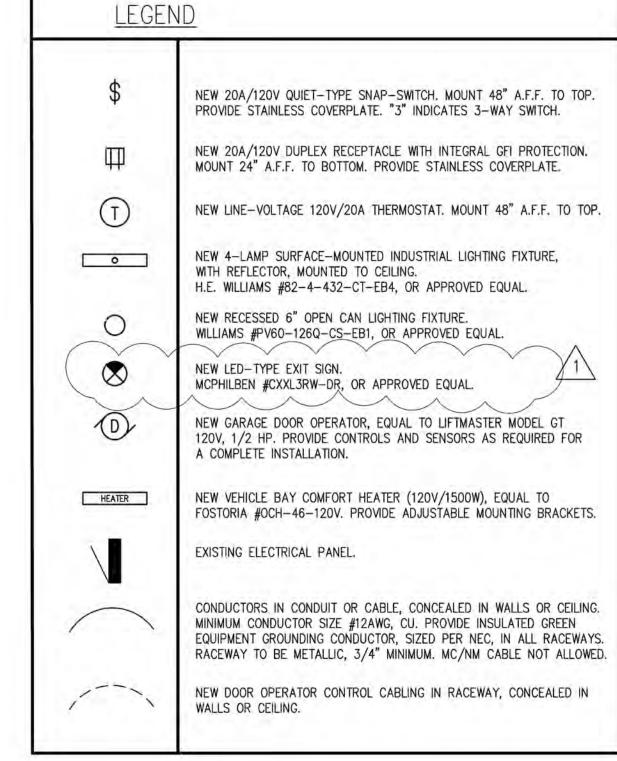

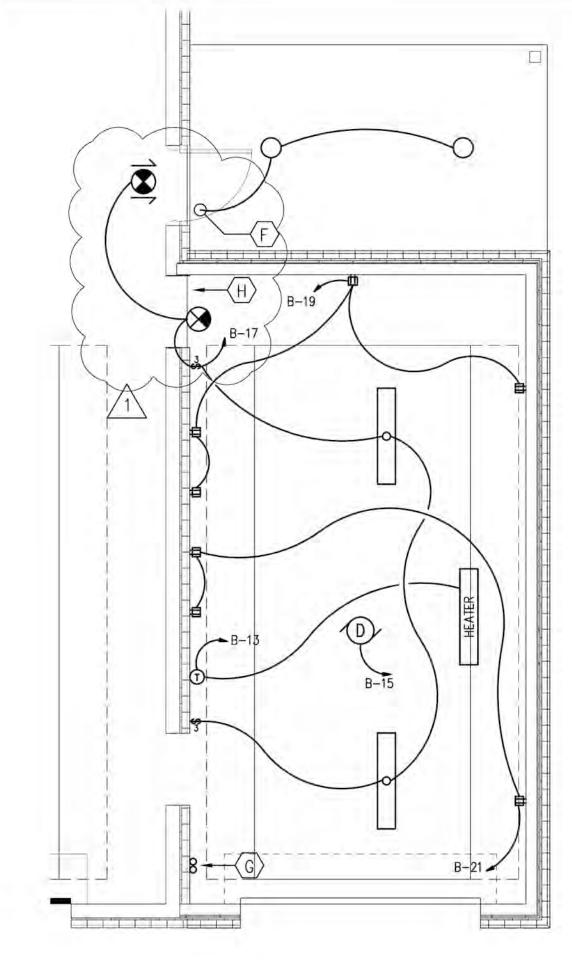



Leon County - Chaires Fire Station Addition


11000 Drawn By: JML
Project Code Checked By: JML

14 April 2011 Date

Construction

Documents

Electrical Plan

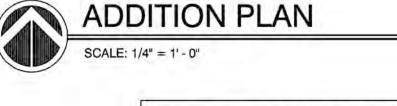

APPLIED RESEARCH AND DESIGN, INC.

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FL CA#8948
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